

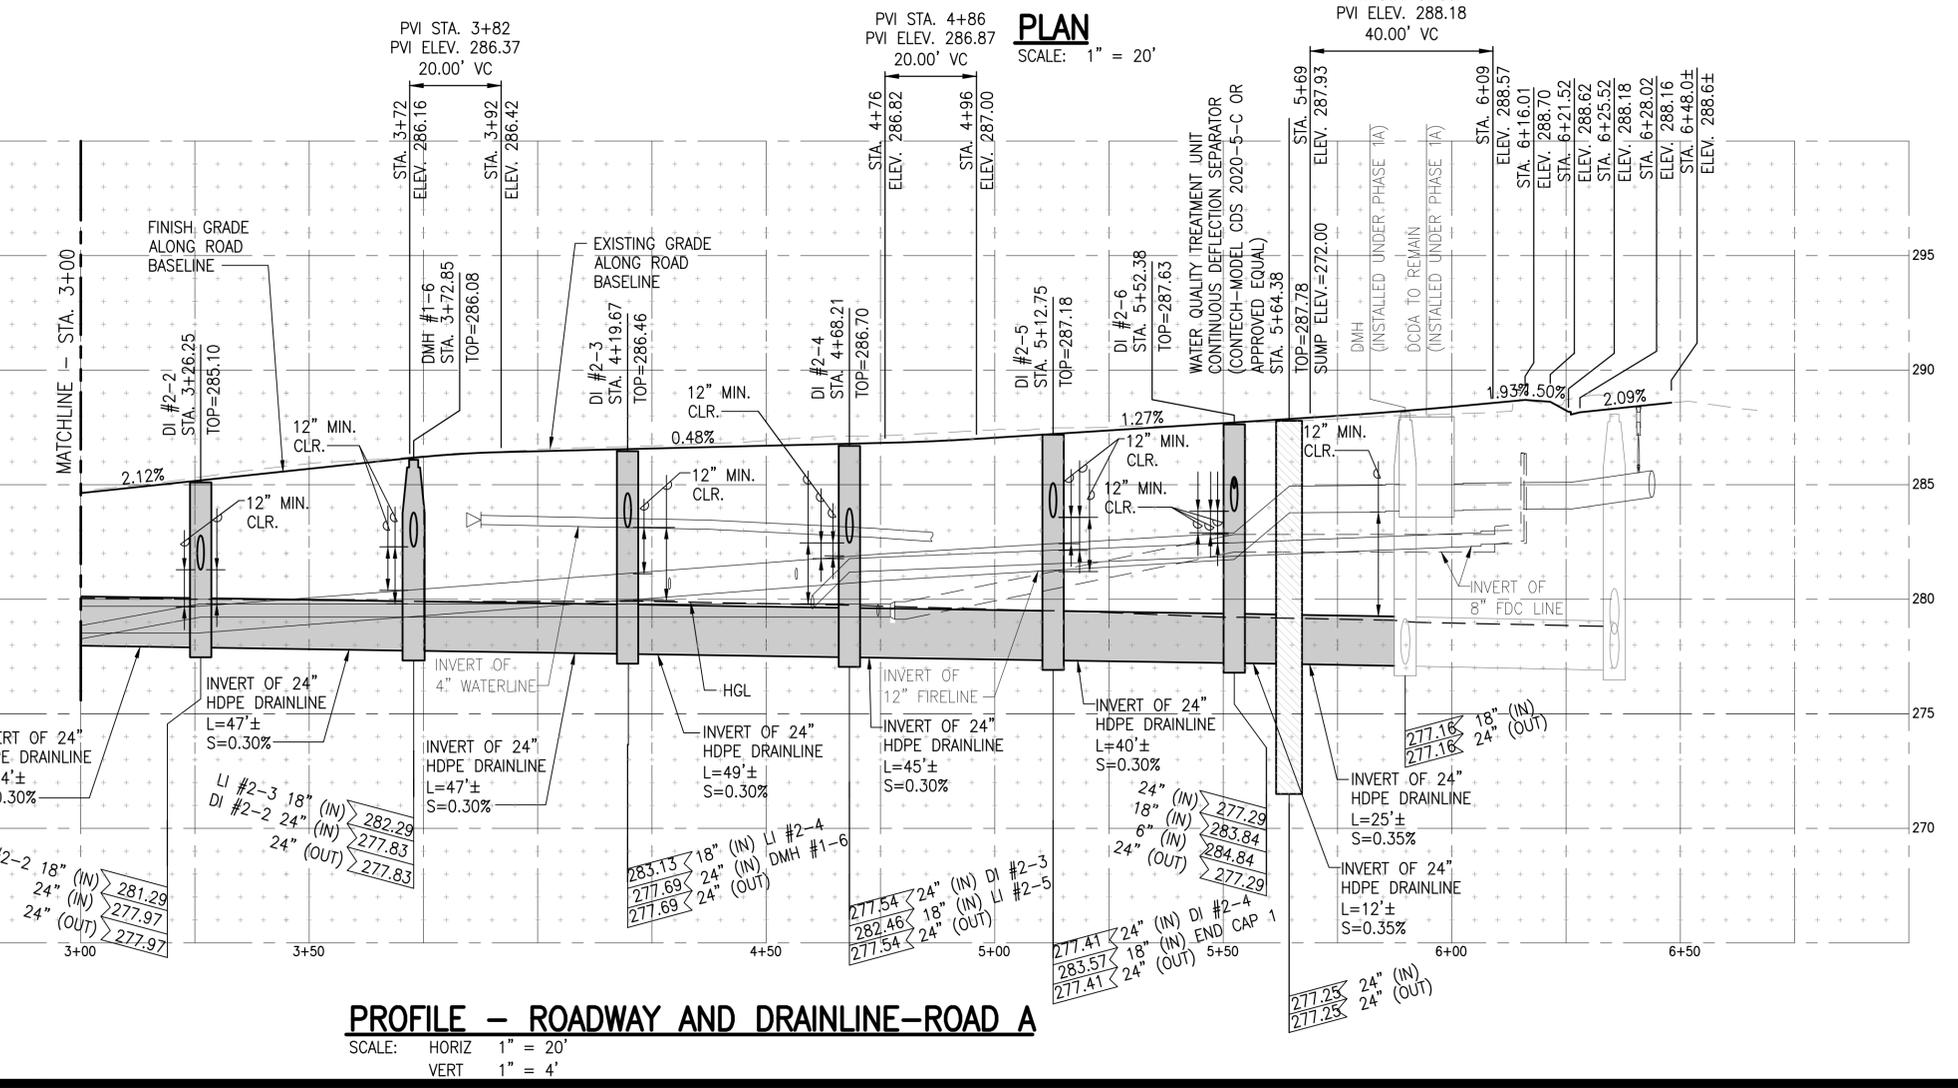
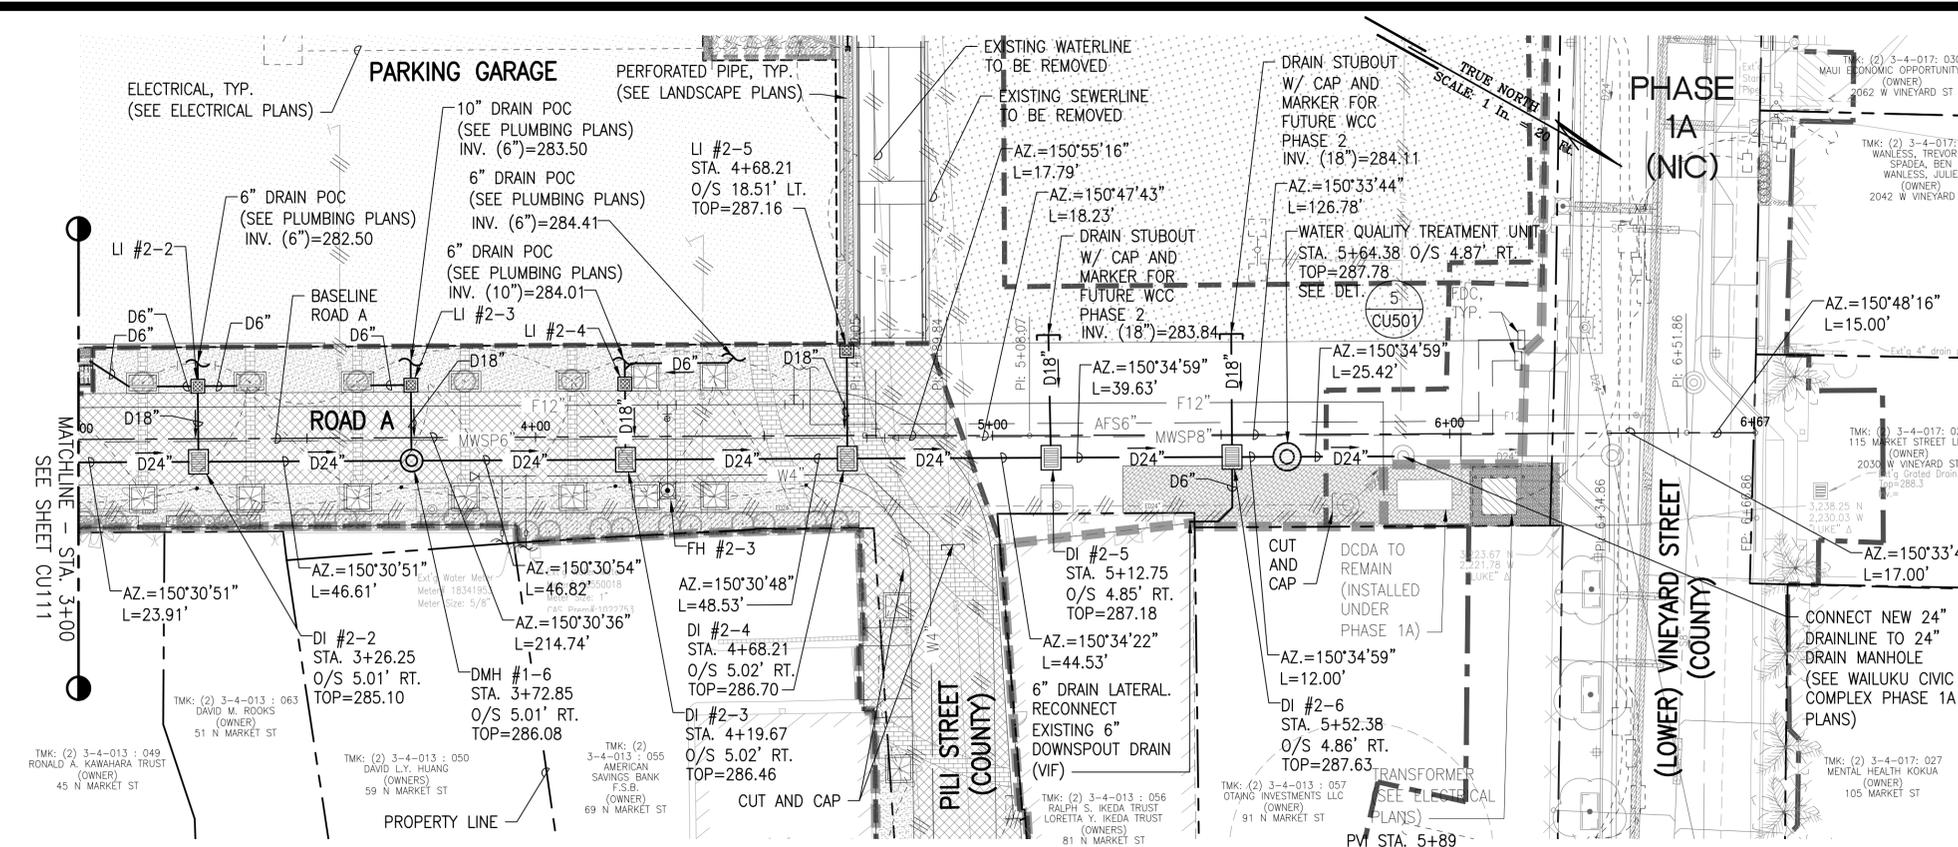
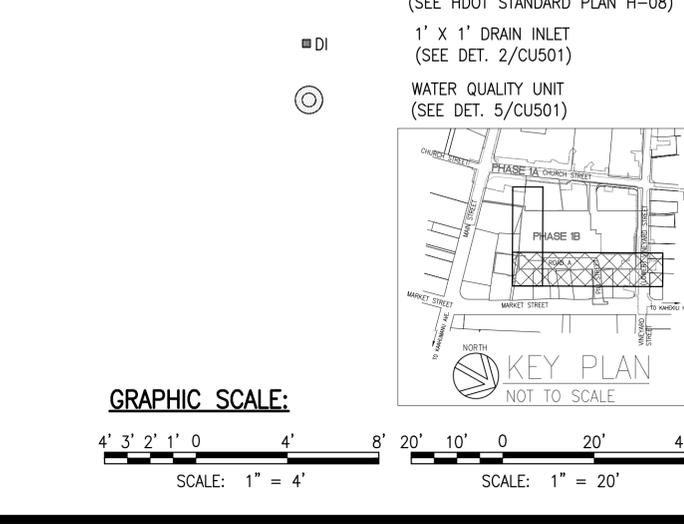



- NOTES:**
- CONTRACTOR SHALL PROVIDE AND INSTALL ALL REQUIRED FITTINGS, APPURTENANCES, AND MATERIALS, AS REQUIRED, TO PROVIDE A COMPLETE, FUNCTIONABLE UTILITY SERVICE SYSTEM CONFORMING TO ALL CURRENT, APPLICABLE STANDARDS AND REQUIREMENTS.
 - CONTRACTOR SHALL INSTALL ALL FITTINGS, AS REQUIRED, TO EXTEND ALL SITE UTILITIES, INCLUDING LATERALS FROM MAINS, TO WITHIN 5 FT. (MAX.) OF BUILDING PERIMETER OR AS REFLECTED IN THE PLANS AND SHALL BEAR ALL COSTS THEREFROM. ALL LATERALS SHALL BE TERMINATED WITH PVC MARKER TO GRADE.
 - CONTRACTOR SHALL VERIFY ALL LOCATIONS OF REQUIRED CONNECTIONS AT BUILDINGS WITH THE MECHANICAL AND ARCHITECTURAL PLANS AND PROVIDE ALL REQUIRED FITTINGS (INCLUDING BUT NOT LIMITED TO REDUCERS, TEMPORARY PLUGS OR CAP, AND MARKERS) AND COORDINATION REQUIRED TO MAKE CONNECTION (BY OTHERS). FINAL CONNECTIONS AT BUILDINGS SHALL BE MADE BY THE BUILDING CONTRACTOR.
 4. DRAINLINES SHALL BE HDPE PIPE (SOIL TIGHT) PER SDOT SPECIFICATIONS. DOMESTIC WATER MAINS AND FIRELINES SHALL BE DUCTILE IRON, CLASS 52 WITH POLYWRAP.
 5. POINT OF CONNECTIONS OF PROPOSED UTILITIES FROM THE PROJECT SITE TO UTILITIES ALONG EXISTING CHURCH STREET AND VINEYARD STREET ARE BASED ON THE AVAILABLE DRAWINGS AND MAYBE INCOMPLETE OR ACTUAL LOCATION, SIZE AND DEPTH MAY VARY. CONTRACTOR SHALL CONDUCT FIELD INVESTIGATION TO CONFIRM EXACT LOCATION, DEPTH, SIZE AND TYPE OF UTILITIES PRIOR TO COMMENCEMENT OF WORK. SHOULD DISCREPANCIES OCCUR, CONTRACTOR SHALL IMMEDIATELY NOTIFY ENGINEER BEFORE PROCEEDING ANY FURTHER WITH THE WORK.
 6. PROVIDE 12" MINIMUM VERTICAL CLEARANCE BETWEEN FIRELINE, WATERLINE AND DRAINLINE. SEE DWS TABLE 100-1.

- LEGEND:**
- PROPERTY LINE
 - BUILDING OUTLINE
 - PHASE 1B BASE BID LIMITS
 - PHASE 1A LATE TURNOVER
 - PHASE 1A (NIC)
 - ROAD CENTERLINE
 - D24" DRAINLINE
 - S8" SEWERLINE
 - W12" WATERLINE
 - F12" FIRELINE
 - AFS6" AUTOMATIC FIRE SPRINKLER
 - MWSP6" MANUAL WET STANDPIPE
 - ELECTRICAL (SEE ELECTRICAL PLANS)
 - FIRE HYDRANT
 - DRAIN MANHOLE (SEE DPW STD. DET. D-22)
 - 2' X 2' LANDSCAPE INLET (SEE DET. 3/CU501)
 - TYPE 61614P AND 1211214P GRATED DROP INLET (SEE HDOT STANDARD PLAN H-12)
 - TYPE 1A-9 AND 1A-9P GRATED DROP INLET (SEE HDOT STANDARD PLAN H-08)
 - 1' X 1' DRAIN INLET (SEE DET. 2/CU501)
 - WATER QUALITY UNIT (SEE DET. 5/CU501)

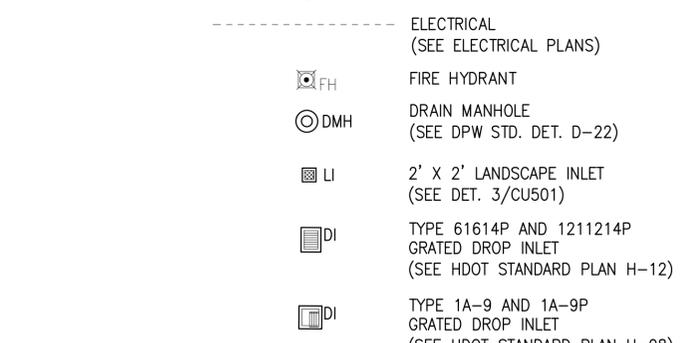


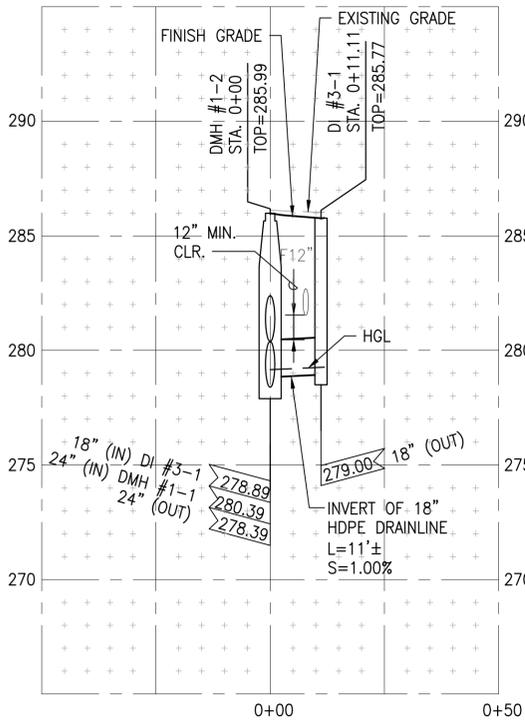



PROFILE - D-1
SCALE: HORIZ 1" = 20'
VERT 1" = 4'

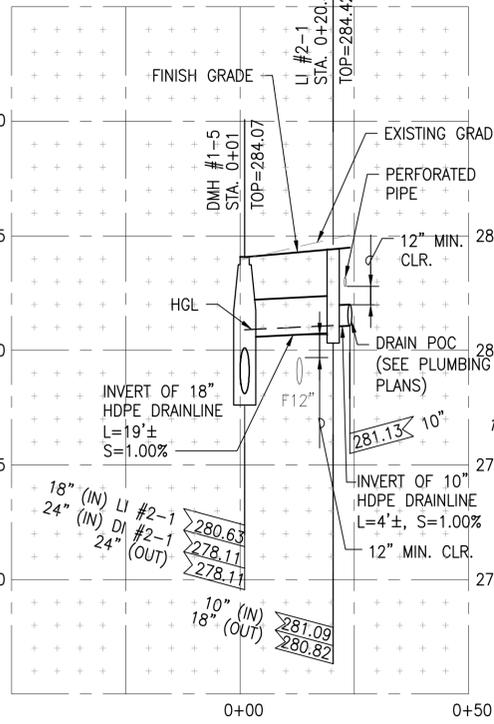


PROFILE - D-2
SCALE: HORIZ 1" = 20'
VERT 1" = 4'

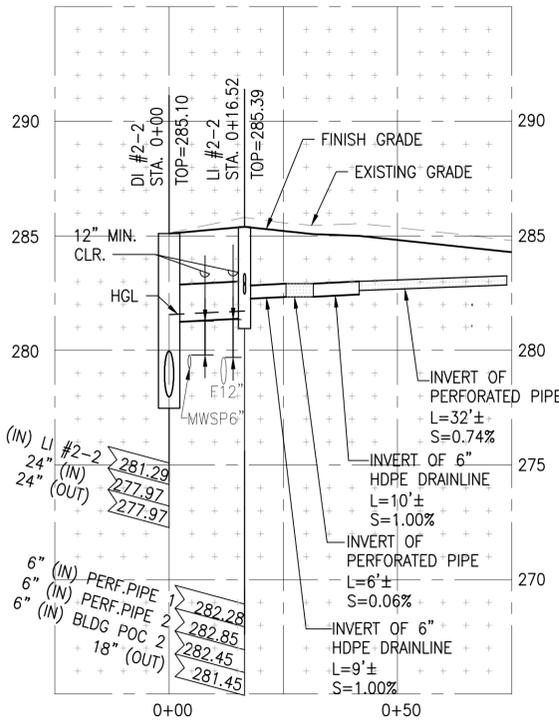


PROFILE - D-3
SCALE: HORIZ 1" = 20'
VERT 1" = 4'

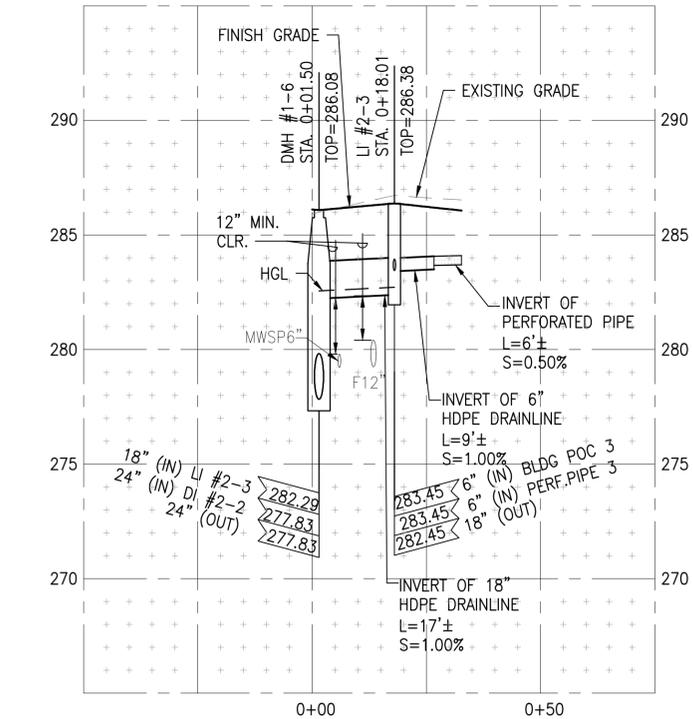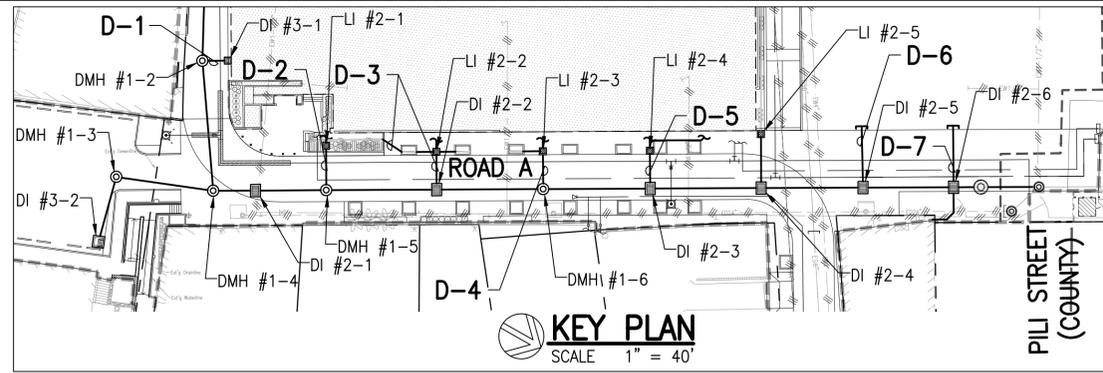


PROFILE - D-4
SCALE: HORIZ 1" = 20'
VERT 1" = 4'

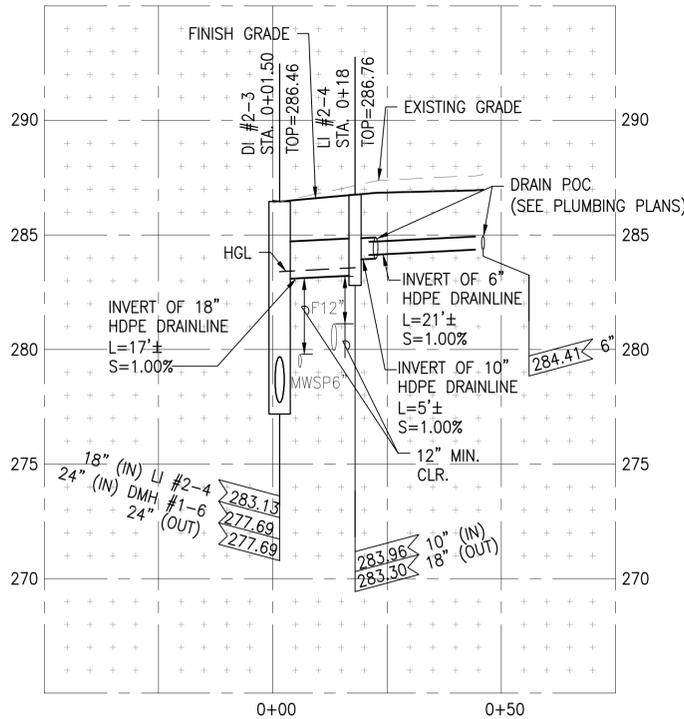

PROFILE - D-5
SCALE: HORIZ 1" = 20'
VERT 1" = 4'

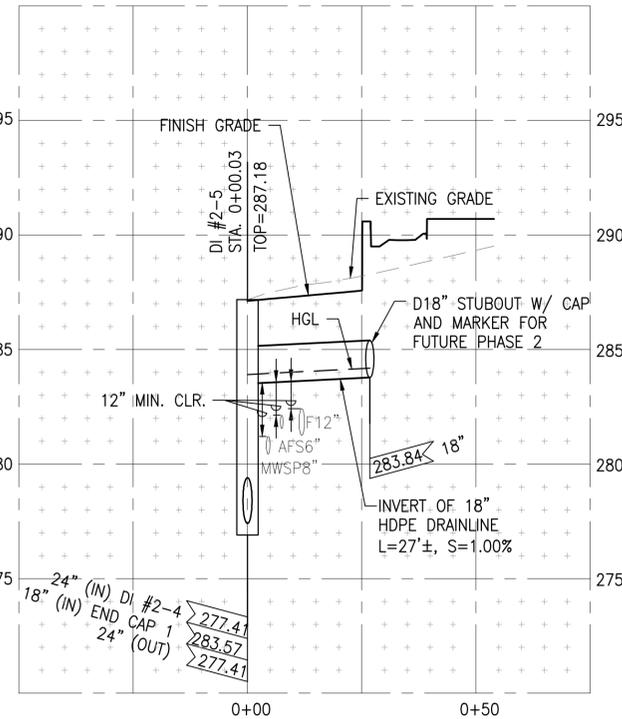

PROFILE - D-6
SCALE: HORIZ 1" = 20'
VERT 1" = 4'

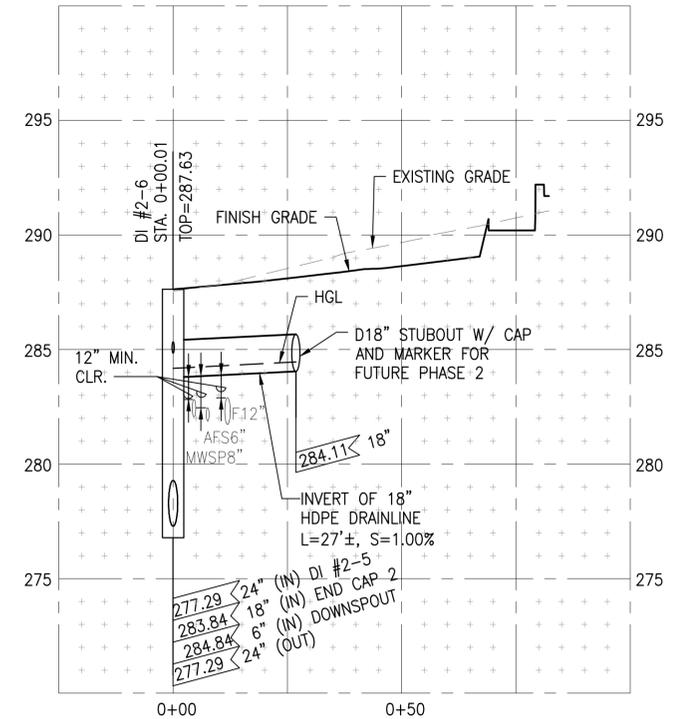

PROFILE - D-7
SCALE: HORIZ 1" = 20'
VERT 1" = 4'

GRAPHIC SCALE:



WAILUKU CIVIC COMPLEX PHASE 1B
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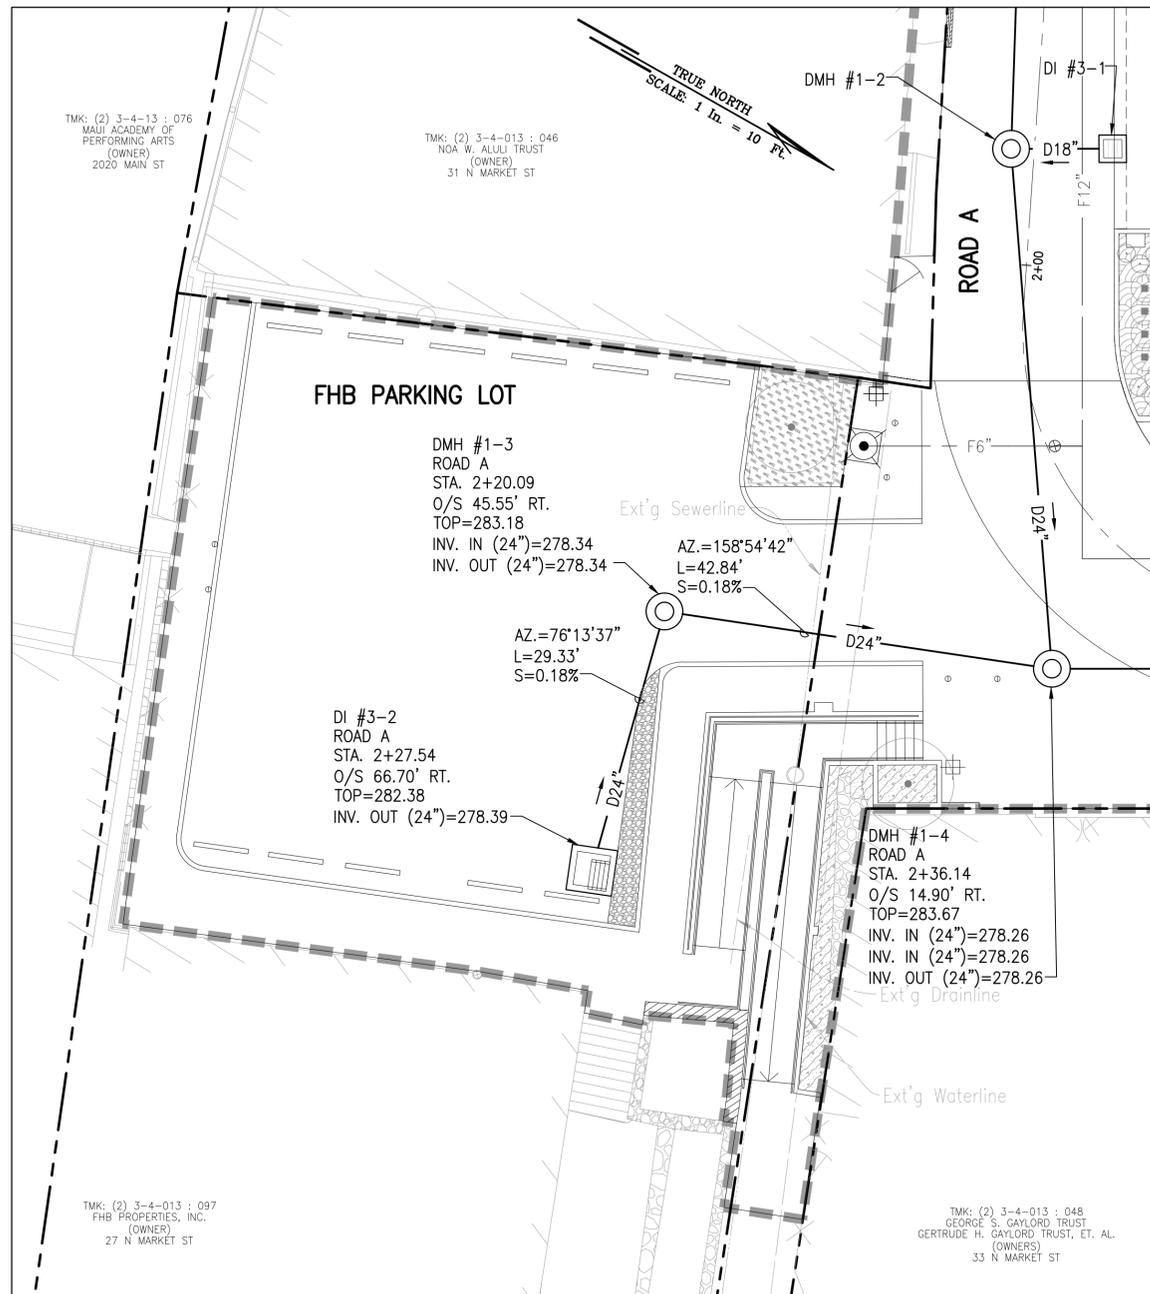
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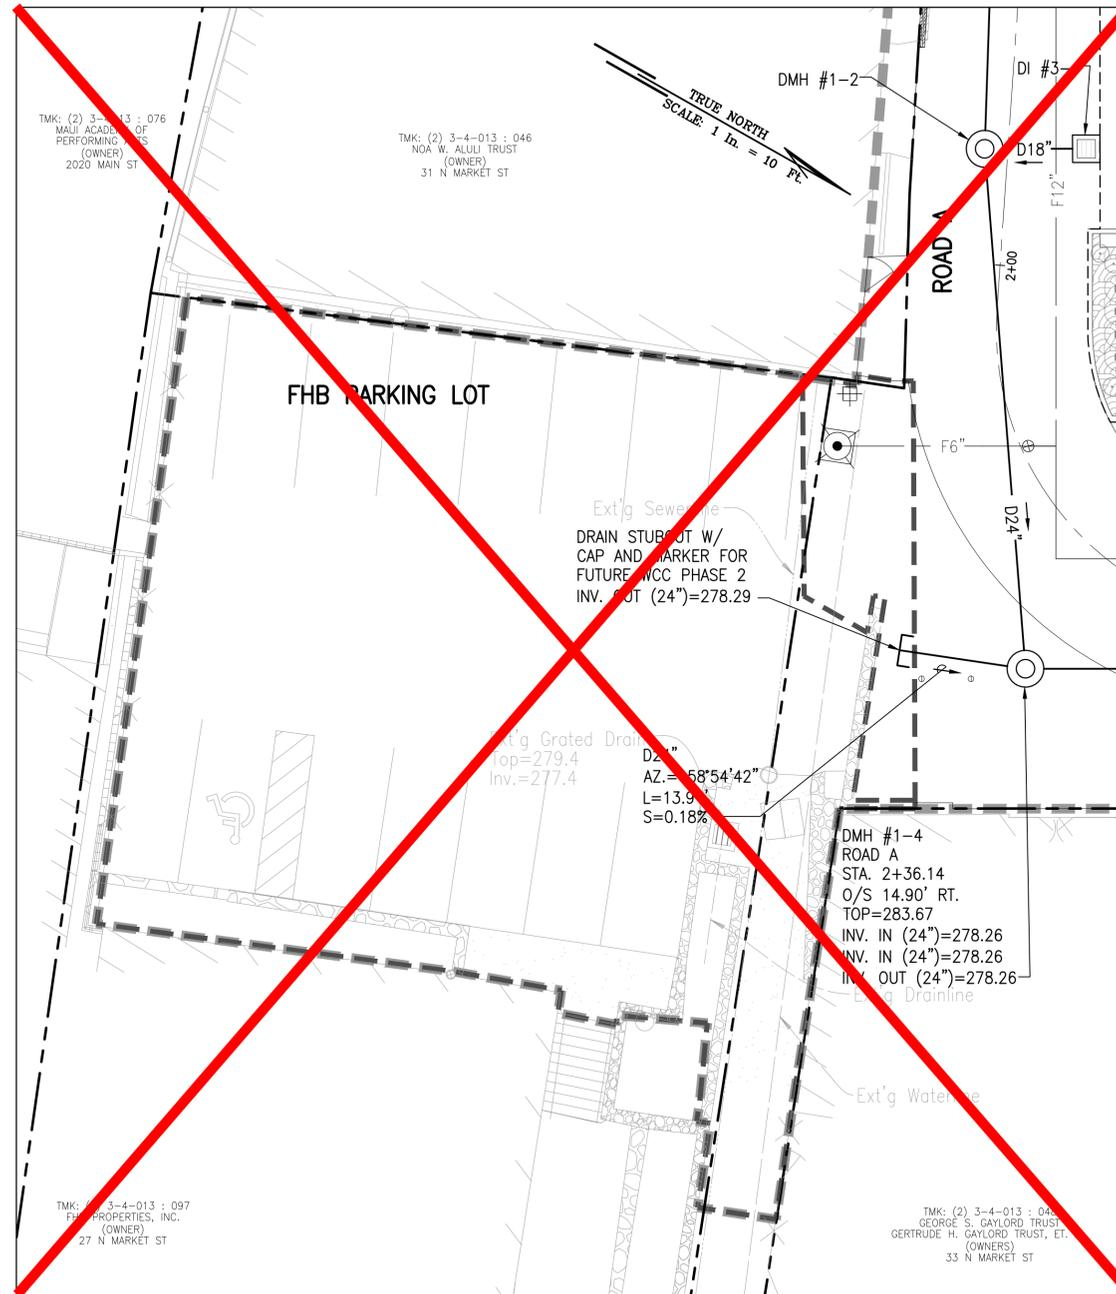
SHEET TITLE:
DRAINLINE ROADWAY CROSSING PROFILE

PROJECT:	WAILUKU CIVIC COMPLEX PHASE 1B
DRAWN:	7/25/2019
DATE:	7/25/2019
PHASE:	1B
SHEET:	CU114
OF SHEETS:	11

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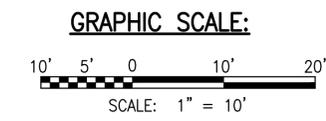
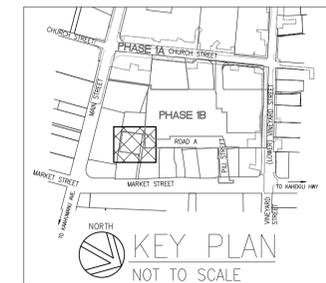


FHB PARKING LOT-BASE BID
SCALE: 1" = 10'



~~**FHB PARKING LOT DEDUCTIVE ALTERNATE NO. D-4**~~
SCALE: 1" = 10'

- LEGEND:**
- PROPERTY LINE
 - PHASE 1B BASE BID LIMITS
 - PHASE 1A LATE TURNOVER
 - BUILDING OUTLINE
 - D24" DRAINLINE
 - F12" FIRELINE
 - BUILDING DRAIN POC (SEE PLUMBING PLANS)
 - ⊙ DMH DRAIN MANHOLE (SEE DPW STD. DET. D-22)
 - ⊙ FH FIRE HYDRANT
 - ELECTRICAL (SEE ELECTRICAL PLANS)
 - ED24" EXISTING DRAINLINE
 - ES8" EXISTING SEWERLINE
 - EW12" EXISTING WATERLINE
 - ☆ EXISTING LIGHT POLE
 - ⊞ DI TYPE 1A-9 AND 1A-9P GRATED DROP INLET (SEE HDOT STANDARD PLAN H-08)




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PHASE 1B
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PROJECT:	DRAWN:	DATE:	SHEET	OF SHEETS
		7/25/2019	1B CU115	
SHEET TITLE:		CADD FILE:		
DETAILED DRAINLINE FHB PARKING LOT BASE BID/ DEDUCTIVE ALTERNATE NO. D-4				
REVISIONS:				




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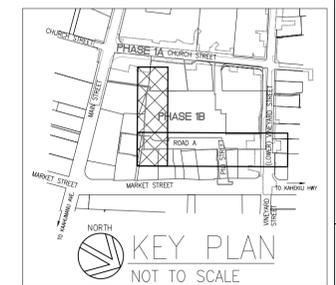
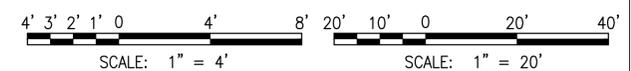
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- POINT OF CONNECTIONS OF PROPOSED UTILITIES FROM THE PROJECT SITE TO UTILITIES ALONG EXISTING CHURCH STREET AND VINEYARD STREET ARE BASED ON THE AVAILABLE DRAWINGS AND MAYBE INCOMPLETE OR ACTUAL LOCATION, SIZE AND DEPTH MAY VARY. CONTRACTOR SHALL CONDUCT FIELD INVESTIGATION TO CONFIRM EXACT LOCATION, DEPTH, SIZE AND TYPE OF UTILITIES PRIOR TO COMMENCEMENT OF WORK. SHOULD DISCREPANCIES OCCUR, CONTRACTOR SHALL IMMEDIATELY NOTIFY ENGINEER BEFORE PROCEEDING ANY FURTHER WITH THE WORK.
- PROVIDE 12" MINIMUM VERTICAL CLEARANCE BETWEEN FIRELINE, WATERLINE AND DRAINLINE. SEE DWS TABLE 100-1.

LEGEND:

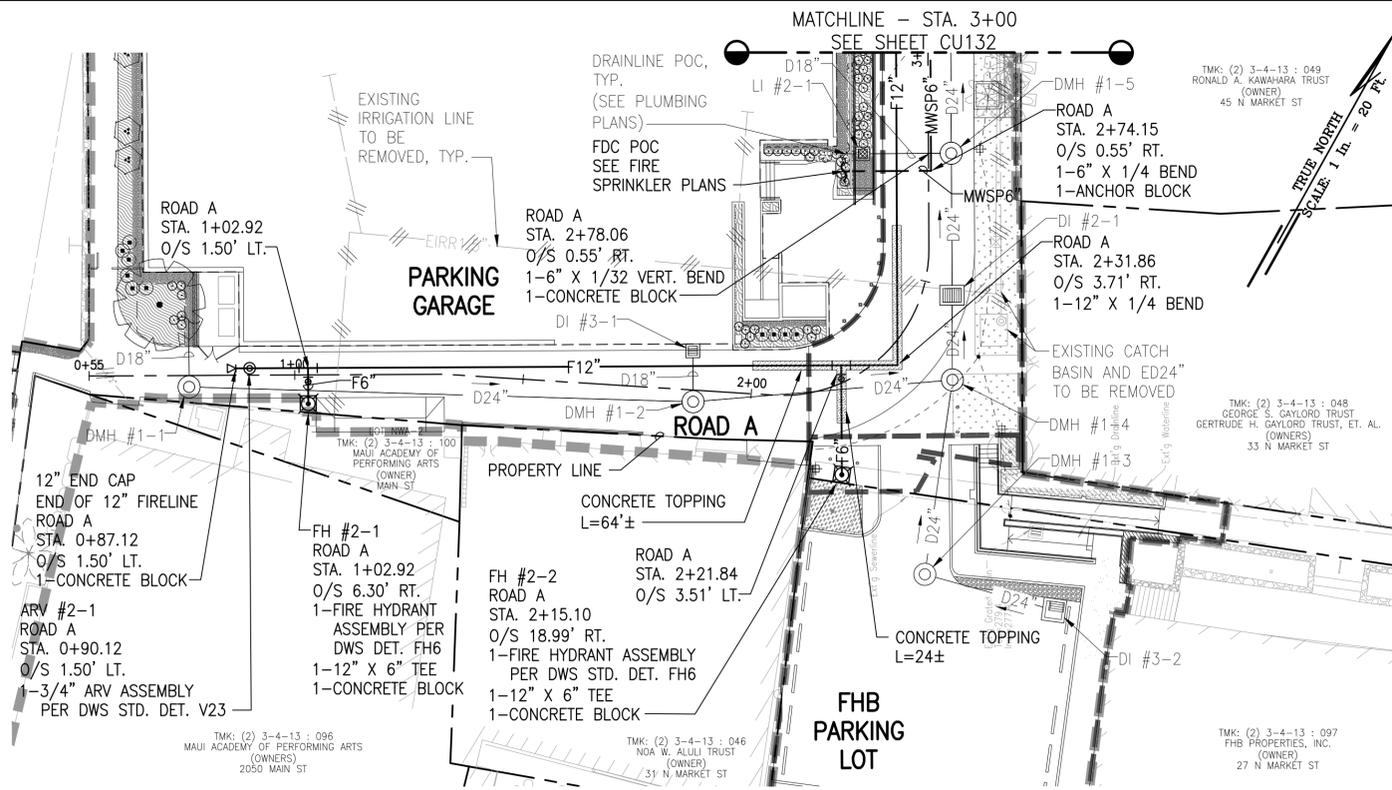- PROPERTY LINE
- - - BUILDING OUTLINE
- ▬▬▬▬▬ PHASE 1B BASE BID LIMITS
- ▬▬▬▬▬ PHASE 1A LATE TURNOVER AND
- ROAD CENTERLINE
- D24" DRAINLINE
- S8" SEWERLINE
- W12" WATERLINE
- F12" FIRELINE
- MWSP6" MANUAL WET STANDPIPE
- ELECTRICAL (SEE ELECTRICAL PLANS)
- FH FIRE HYDRANT (SEE DWS STD. DET. FH6)
- EXISTING FIRE HYDRANT
- DMH DRAIN MANHOLE
- DI DRAIN INLET
- LI LANDSCAPE INLET

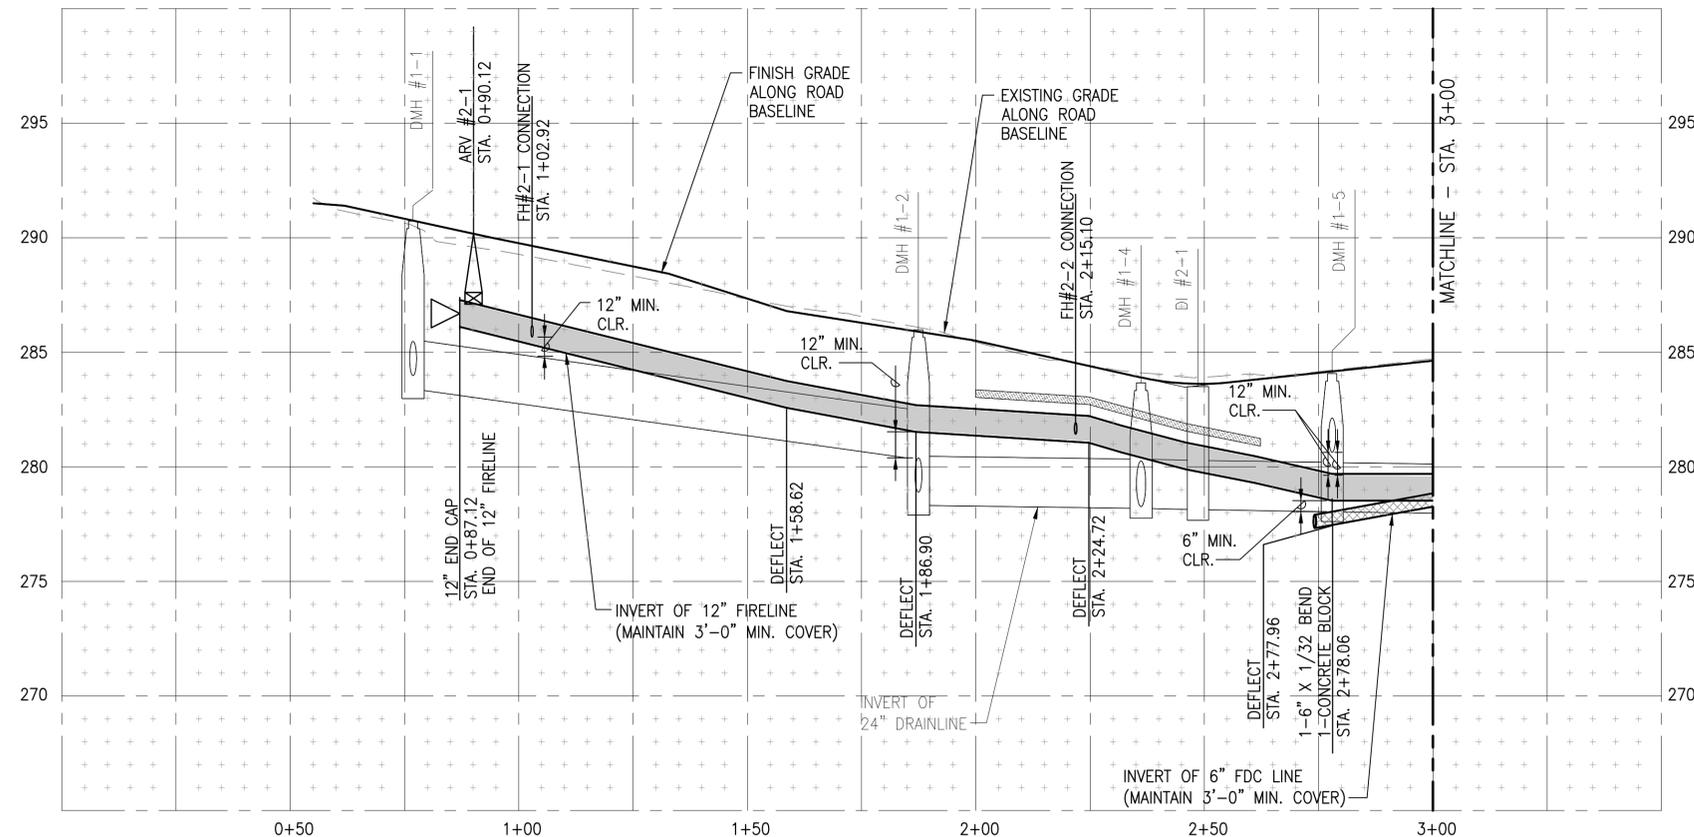

GRAPHIC SCALE:



**WAILUKU CIVIC COMPLEX
PHASE 1B
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**PLAN AND PROFILE:
WATERLINE AND
FIRELINE - ROAD A**

PROJECT: _____

DRAWN: _____

DATE: 7/25/2019

PHASE SHEET

1B CU131

OF SHEETS

SHEET TITLE:

PLAN AND PROFILE:
WATERLINE AND
FIRELINE - ROAD A

REVISIONS:

PLAN AND PROFILE:
WATERLINE AND
FIRELINE - ROAD A

CADD FILE:

PLAN AND PROFILE:
WATERLINE AND
FIRELINE - ROAD A

**WAILUKU CIVIC COMPLEX
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**PLAN AND PROFILE:
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REVISIONS:

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FIRELINE - ROAD A

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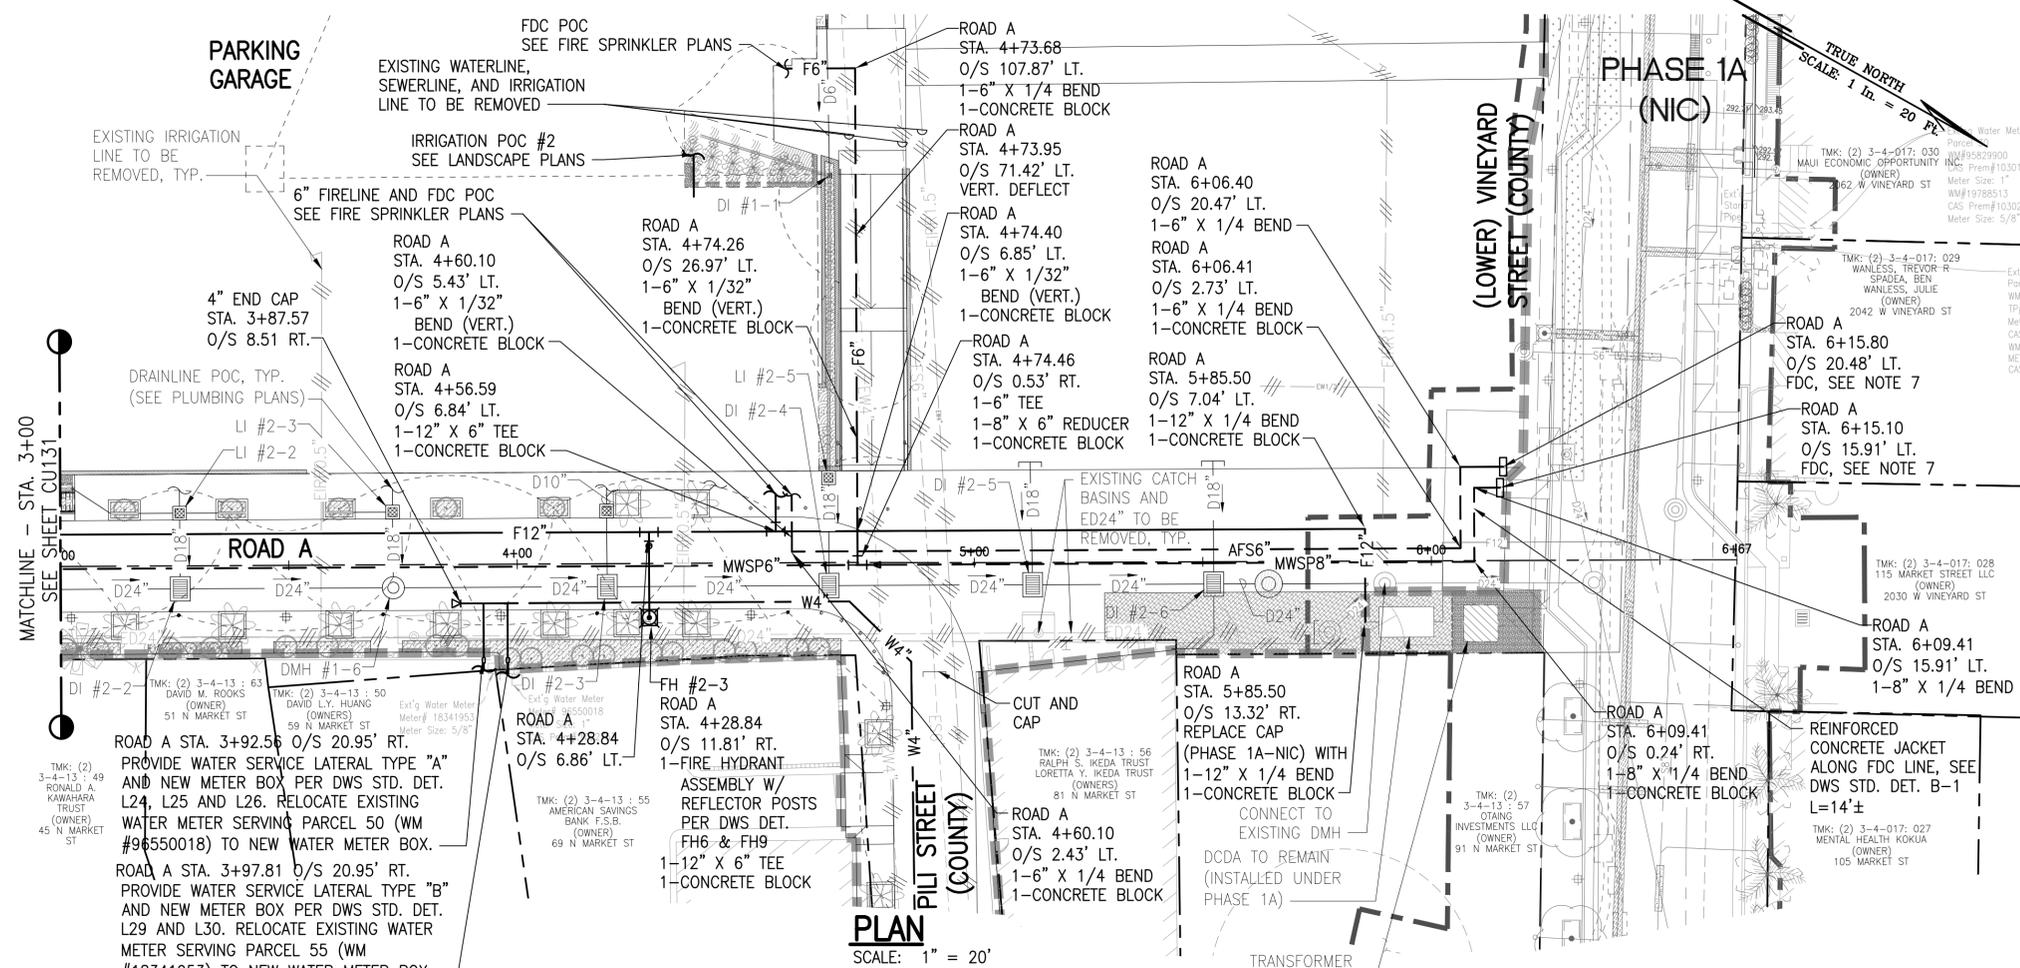
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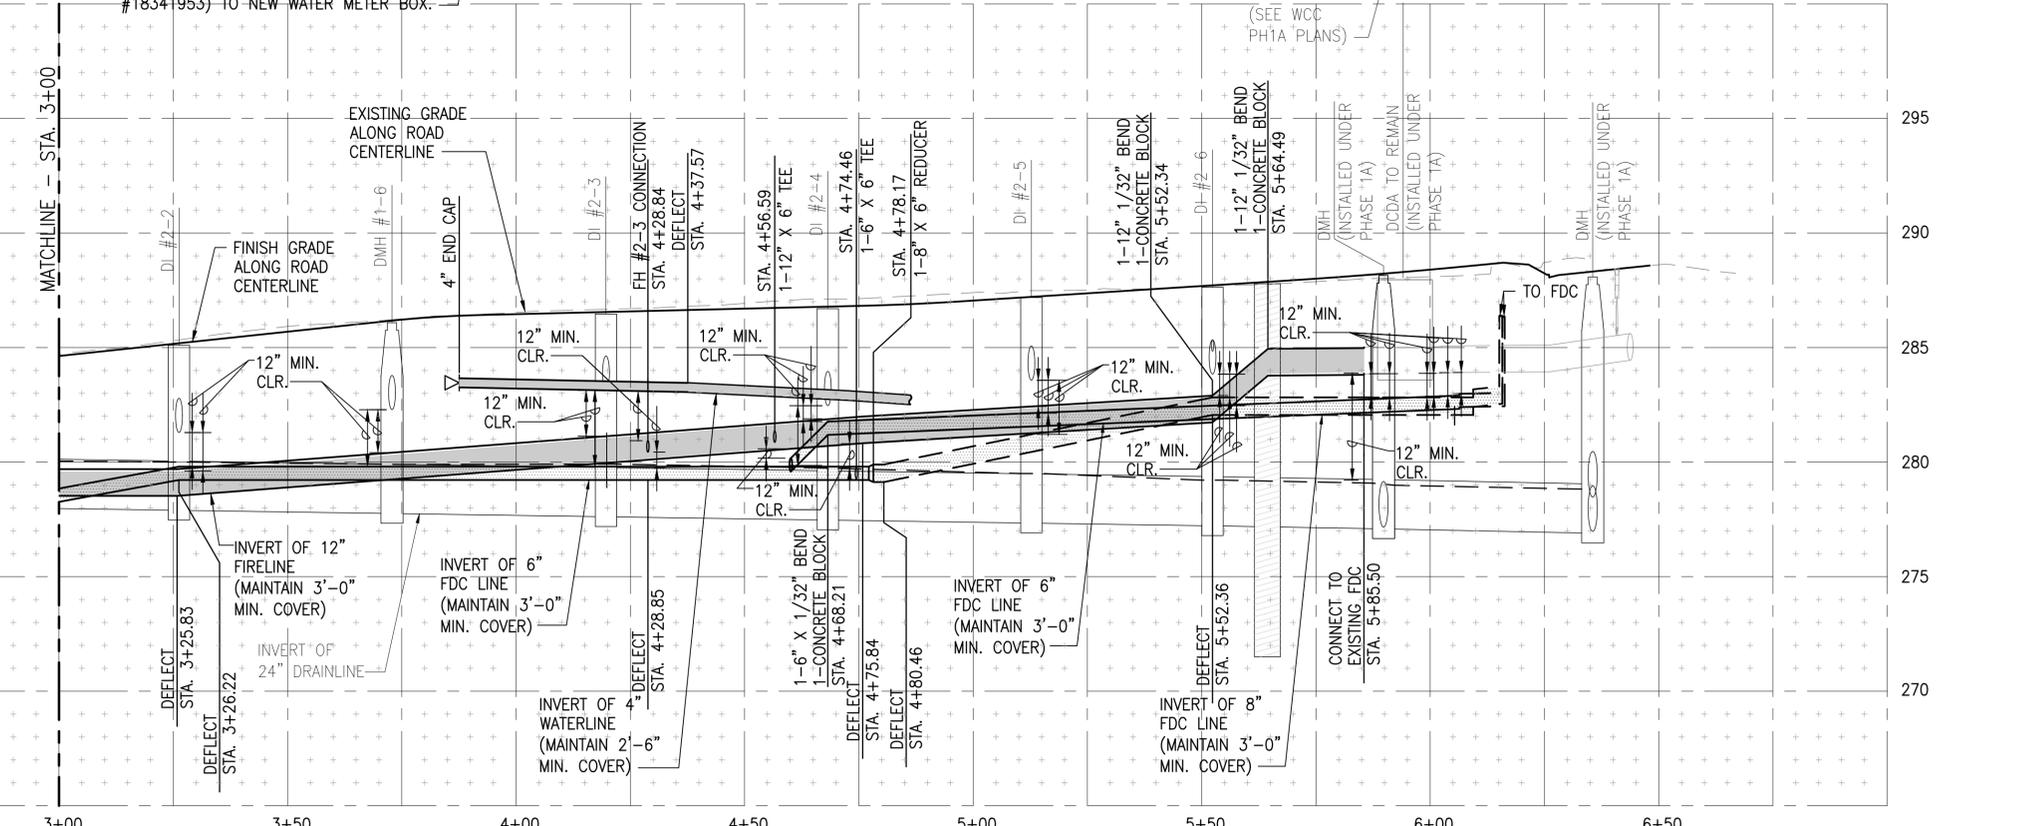
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Signature: *Kent G. McLain*



PLAN
SCALE: 1" = 20'



PROFILE - WATERLINE AND FIRELINE - ROAD A
SCALE: HORIZ 1" = 20'
VERT 1" = 4'



NOTES:

- CONTRACTOR SHALL PROVIDE AND INSTALL ALL REQUIRED FITTINGS, APPURTENANCES, AND MATERIALS, AS REQUIRED, TO PROVIDE A COMPLETE, FUNCTIONABLE UTILITY SERVICE SYSTEM CONFORMING TO ALL CURRENT, APPLICABLE STANDARDS AND REQUIREMENTS.
- CONTRACTOR SHALL INSTALL ALL FITTINGS, AS REQUIRED, TO EXTEND ALL SITE UTILITIES, INCLUDING LATERALS FROM MAINS, TO WITHIN 5 FT. (MAX.) OF BUILDING PERIMETER OR AS REFLECTED IN THE PLANS AND SHALL BEAR ALL COSTS THEREFROM. ALL LATERALS SHALL BE TERMINATED WITH PVC MARKER TO GRADE.
- CONTRACTOR SHALL VERIFY ALL LOCATIONS OF REQUIRED CONNECTIONS AT BUILDINGS WITH THE MECHANICAL AND ARCHITECTURAL PLANS AND PROVIDE ALL REQUIRED FITTINGS (INCLUDING BUT NOT LIMITED TO REDUCERS, TEMPORARY PLUGS OR CAP, AND MARKERS) AND COORDINATION REQUIRED TO MAKE CONNECTION (BY OTHERS). FINAL CONNECTIONS AT BUILDINGS SHALL BE MADE BY THE BUILDING CONTRACTOR.
- DRAINLINES SHALL BE HDPE PIPE (SOIL TIGHT) PER SDOT SPECIFICATIONS. DOMESTIC WATER MAINS AND FIRELINES SHALL BE DUCTILE IRON, CLASS 52 WITH POLYWRAP.
- POINT OF CONNECTIONS OF PROPOSED UTILITIES FROM THE PROJECT SITE TO UTILITIES ALONG EXISTING CHURCH STREET AND VINEYARD STREET ARE BASED ON THE AVAILABLE DRAWINGS AND MAYBE INCOMPLETE OR ACTUAL LOCATION, SIZE AND DEPTH MAY VARY. CONTRACTOR SHALL CONDUCT FIELD INVESTIGATION TO CONFIRM EXACT LOCATION, DEPTH, SIZE AND TYPE OF UTILITIES PRIOR TO COMMENCEMENT OF WORK. SHOULD DISCREPANCIES OCCUR, CONTRACTOR SHALL IMMEDIATELY NOTIFY ENGINEER BEFORE PROCEEDING ANY FURTHER WITH THE WORK.
- PROVIDE 12" MINIMUM VERTICAL CLEARANCE BETWEEN FIRELINE, WATERLINE AND DRAINLINE. SEE DWS TABLE 100-1.
- FOR FIRE DEPARTMENT CONNECTION DETAIL, SEE FIRE SPRINKLER PLANS.

LEGEND:

- PROPERTY LINE
- PHASE 1B BASE BID LIMITS
- PHASE 1A LATE TURNOVER
- PHASE 1A (NIC)
- BUILDING OUTLINE
- ROAD CENTERLINE
- D24" DRAINLINE
- S8" SEWERLINE
- W12" WATERLINE
- FDC12" FIRELINE
- AFS6" AUTOMATIC FIRE SPRINKLER
- MWSP8" MANUAL WET STANDPIPE
- ELECTRICAL (SEE ELECTRICAL PLANS)
- COTG CLEANOUT
- ⊙ DMH DRAIN MANHOLE
- ⊙ FH FIRE HYDRANT
- ⊙ EXISTING FIRE HYDRANT
- ⊙ LI LANDSCAPE INLET
- ⊙ DI DRAIN INLET

GRAPHIC SCALE:

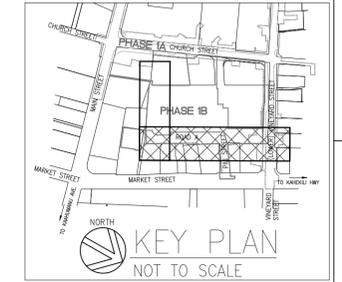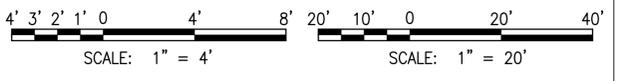

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WAILUKU CIVIC COMPLEX PHASE 1B
100% FINAL DESIGN

PLAN AND PROFILE: WATERLINE AND FIRELINE - ROAD A

PROJECT:	DRAWN:	DATE:	SHEET	OF	SHEETS
		7/25/2019	1B	CU132	

REVISIONS:

NO.	DESCRIPTION	DATE


SHEET TITLE: PLAN AND PROFILE: WATERLINE AND FIRELINE - ROAD A

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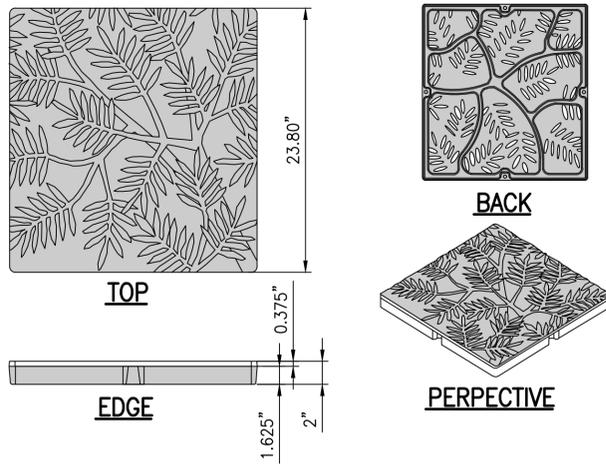
REGISTERED PROFESSIONAL ENGINEER
NO. 11328-C
HAWAII

FERRARO CHOI

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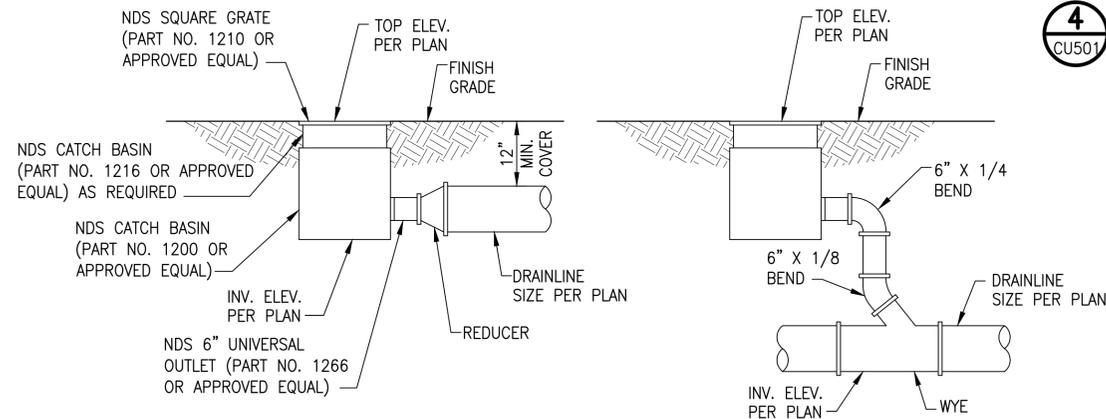


1 DRAIN LINE TRENCH DETAIL
CU501 NOT TO SCALE

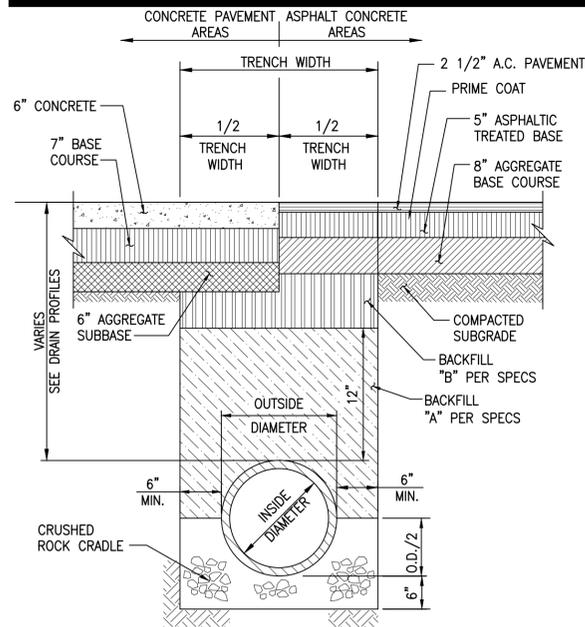


- NOTES:**
1. MATERIAL: CAST IRON
 2. FINISH: BAKED ON OIL FINISH
 3. TOTAL THICKNESS: 2"
 4. REPLACES DRAIN MANUFACTURED BY: NDS 2400 SERIES
 5. NO OPENING GREATER THAN 1/2"
 6. DUE TO CASTING INCONSISTENCIES ALL DIMENSION ARE NOMINAL
 7. GRATES SHALL BE TRAFFIC RATED WHEN LOCATED IN VEHICULAR AREAS.

4 FOR 2'X2' LANDSCAPE INLET FRAME AND GRATE DETAILS
CU501 NOT TO SCALE



2 1'X1' DRAIN INLET
CU501 NOT TO SCALE

- NOTES:**
1. USE NDS SQUARE GRATE PART NO. 2411 OR APPROVED EQUAL FOR 2'X2' DRAIN INLET
 2. USE IRON AGE LOCUST 24" SQ. FOR 2'X2' LANDSCAPE INLET, SEE DET. 4/CU501


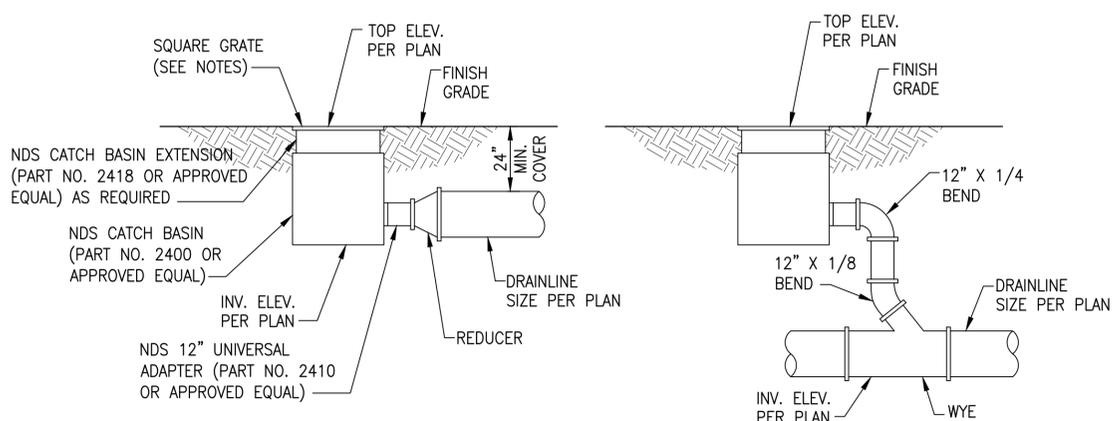


3 2'X2' DRAIN AND LANDSCAPE INLET
CU501 NOT TO SCALE


- GENERAL NOTES:**
1. CONTECH TO PROVIDE ALL MATERIALS UNLESS NOTED OTHERWISE.
 2. DIMENSIONS MARKED WITH () ARE REFERENCE DIMENSIONS. ACTUAL DIMENSIONS MAY VARY.
 3. FOR FABRICATION DRAWINGS WITH DETAILED STRUCTURE DIMENSIONS AND WEIGHTS, PLEASE CONTACT YOUR CONTECH ENGINEERED SOLUTIONS LLC REPRESENTATIVE. WWW.CONTECHES.COM
 4. CDS WATER QUALITY STRUCTURE SHALL BE IN ACCORDANCE WITH ALL DESIGN DATA AND INFORMATION CONTAINED IN THIS DRAWING.
 5. STRUCTURE SHALL MEET AASHTO HS20 AND CASTINGS SHALL MEET HS20 (AASHTO M 306) LOAD RATING, ASSUMING GROUNDWATER ELEVATION AT, OR BELOW, THE OUTLET PIPE INVERT ELEVATION. ENGINEER OF RECORD TO CONFIRM ACTUAL GROUNDWATER ELEVATION.
 6. PVC HYDRAULIC SHEAR PLATE IS PLACED ON SHELF AT BOTTOM OF SCREEN CYLINDER. REMOVE AND REPLACE AS NECESSARY DURING MAINTENANCE CLEANING.

- INSTALLATION NOTES:**
- A. ANY SUB-BASE, BACKFILL DEPTH, AND/OR ANTI-FLOTATION PROVISIONS ARE SITE-SPECIFIC DESIGN CONSIDERATIONS AND SHALL BE SPECIFIED BY ENGINEER OF RECORD.
 - B. CONTRACTOR TO PROVIDE EQUIPMENT WITH SUFFICIENT LIFTING AND REACH CAPACITY TO LIFT AND SET THE CDS MANHOLE STRUCTURE (LIFTING CLUTCHES PROVIDED).
 - C. CONTRACTOR TO ADD JOINT SEALANT BETWEEN ALL STRUCTURE SECTIONS, AND ASSEMBLE STRUCTURE.
 - D. CONTRACTOR TO PROVIDE, INSTALL, AND GROUT PIPES. MATCH PIPE INVERTS WITH ELEVATIONS SHOWN.
 - E. CONTRACTOR TO TAKE APPROPRIATE MEASURES TO ASSURE UNIT IS WATER TIGHT, HOLDING WATER TO FLOWLINE INVERT MINIMUM. IT IS SUGGESTED THAT ALL JOINTS BELOW PIPE INVERTS ARE GROUTED.

5 CDS2020-5-C INLINE CDS DETAIL
CU501 NOT TO SCALE

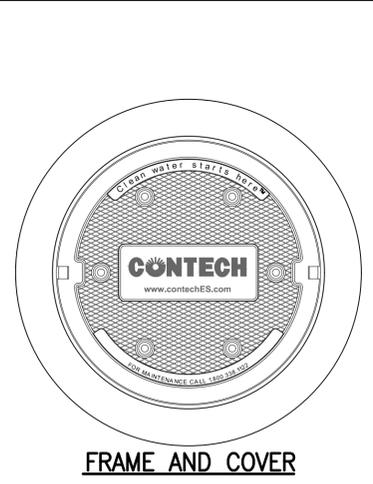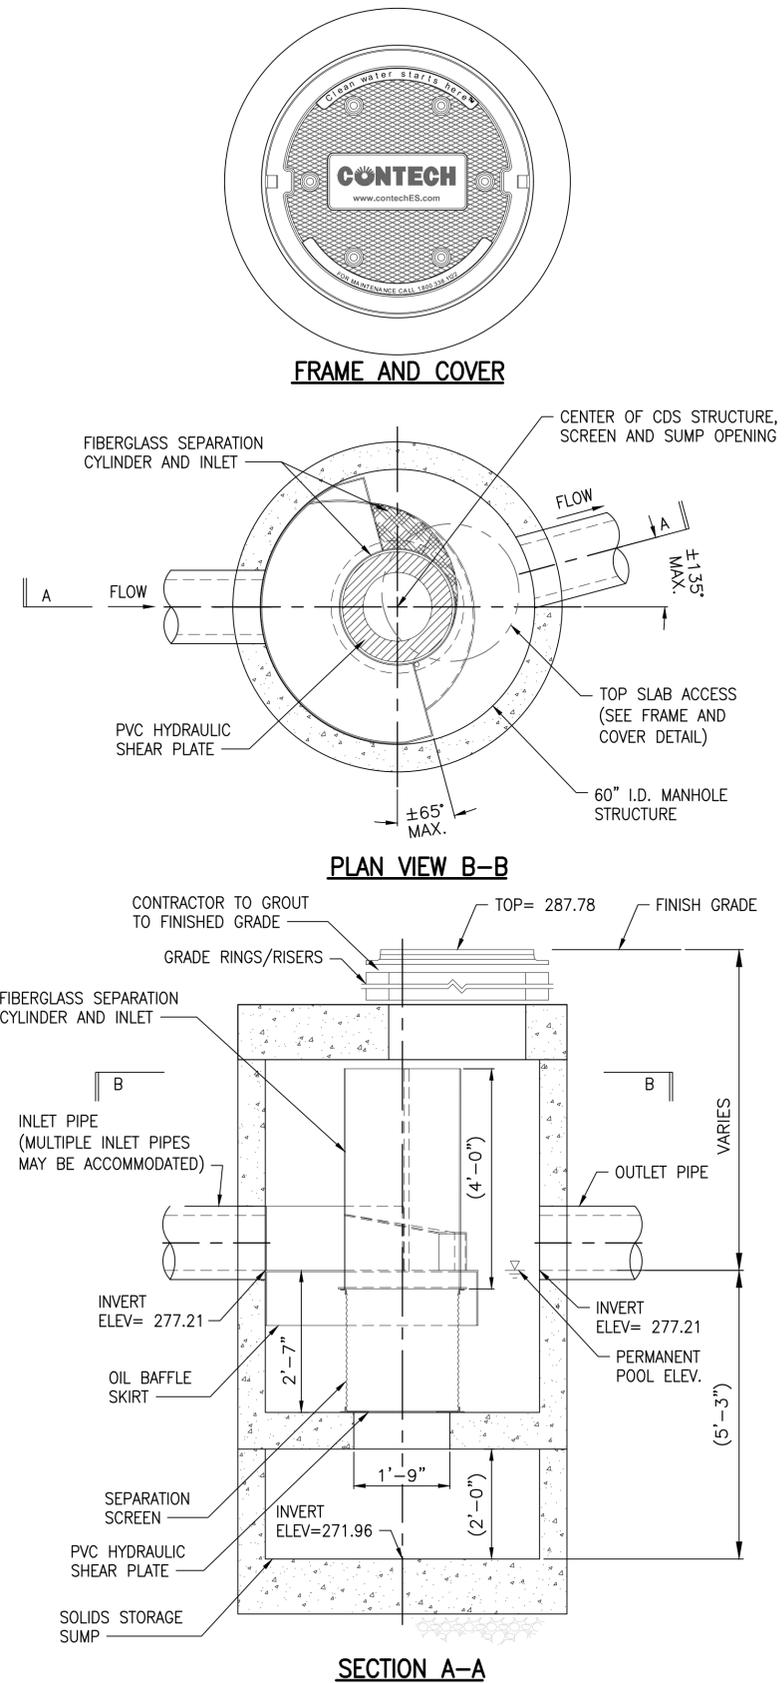

FRAME AND COVER

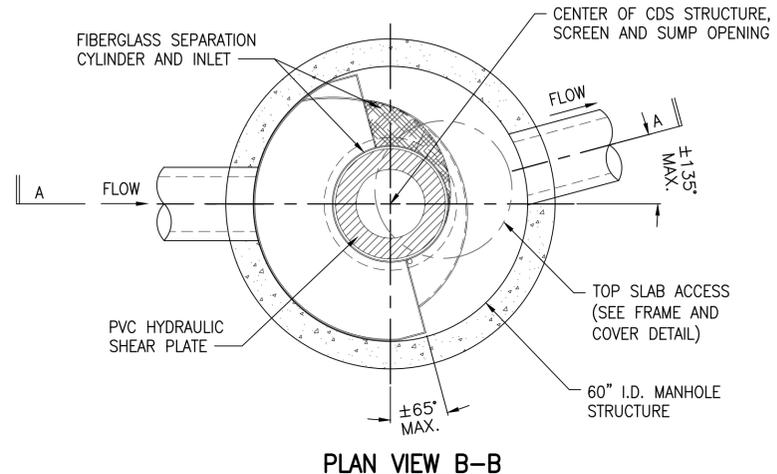

PLAN VIEW B-B

SECTION A-A

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REGISTERED PROFESSIONAL ENGINEER
NO. 11328-C
HAWAII

WAILUKU CIVIC COMPLEX PHASE 1B
100% FINAL DESIGN
[Signature]

PROJECT:	WAILUKU CIVIC COMPLEX PHASE 1B
DRAWN:	7/25/2019
DATE:	7/25/2019
PHASE:	100% FINAL DESIGN
SHEET:	CU501
OF:	SHEETS
SHEET TITLE:	DRAIN DETAILS
REVISIONS:	
CADD FILE:	


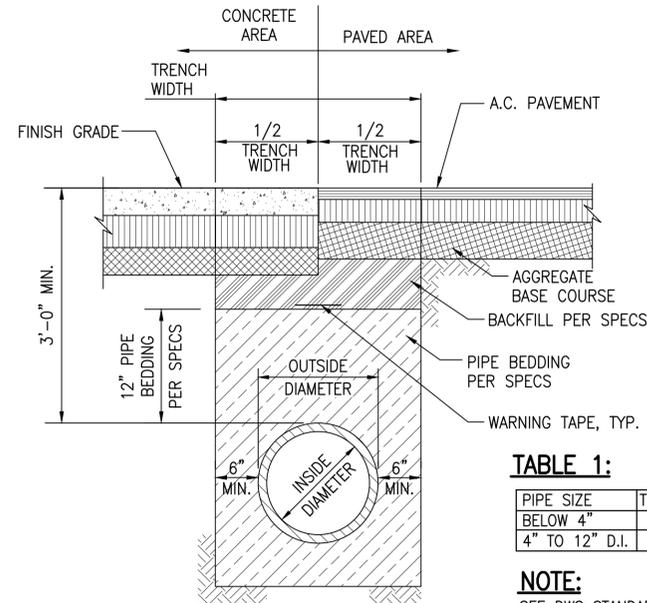


TABLE 1:

PIPE SIZE	TRENCH WIDTH
BELOW 4"	12"
4" TO 12" D.I.	24"

NOTE:
SEE DWS STANDARD
DETAIL P10 FOR DETAILS.

1 WATER/FIRE LINE TRENCH DETAIL
CU503 NOT TO SCALE

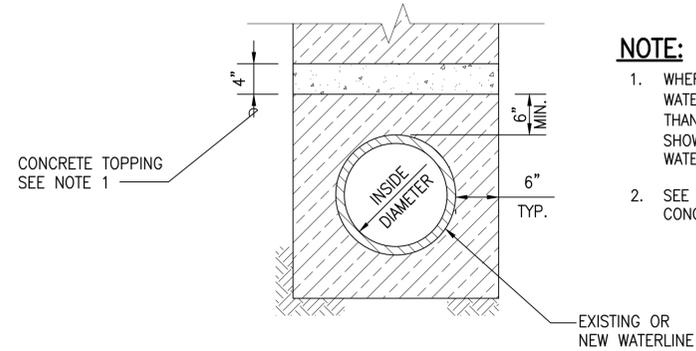

NOTE:

- WHERE COVER OVER NEW OR EXISTING WATERLINE IS LESS THAN 3' BUT GREATER THAN 2', CONSTRUCT CONCRETE TOPPING AS SHOWN. IF COVER IS LESS THAN 2', JACKET WATERLINE. SEE DWS STD. DET. B1
- SEE SHEET CU102 FOR LOCATION OF NEW CONCRETE TOPPING.

2 CONCRETE TOPPING
CU503 NOT TO SCALE

THE FOLLOWING DETAILS AS SHOWN ON "WATER SYSTEM STANDARDS 2002" ARE SPECIFICALLY REFERENCED WITHIN THESE PLANS AND SHALL BE CONSIDERED PART OF THE CONSTRUCTION DRAWINGS. (THIS SHALL NOT BE CONSTRUED TO RELIEVE THE CONTRACTOR FROM COMPLYING WITH ALL PERTINENT PARTS OF THE AFOREMENTIONED LIST, STANDARD DETAILS, AND STANDARDS.)

DETAIL	DESCRIPTION
FH6	HYDRANT CONNECTION - STRAIGHT RUN
FH9	HYDRANT CONCRETE SLAB AND REFLECTOR POST
L24	TYPICAL SERVICE LATERAL
L25 AND L26	SINGLE SERVICE LATERAL TYPE "A", 5/8" & 3/4" METERS
L29 AND L30	SINGLE SERVICE LATERAL TYPE "B", 1" METER
V23	ARV INSTALLATION TYPE "F" MANHOLE

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SIGNATURE
Kenneth G. McLaughlin

EXPIRATION OF LICENSE
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WAILUKU CIVIC COMPLEX PHASE 1B
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[PUVABUUIUPUVUWUP]

SHEET TITLE:
WATER AND FIRE DETAILS

REVISIONS:

PROJECT:
DRAWN:
DATE: 7/25/2019
PHASE SHEET
1B CU503
OF SHEETS

CADD FILE:

SITE FURNISHINGS SCHEDULE (BASE BID)						
SYMBOL	TYPE	MATERIAL	COLOR	FINISH	THICKNESS	PATTERN
—	Bike Rack	Landscapeforms Ring Bike Rack (1.5" O.D. 120" wall stainless steel tubing), 25" W x 27" H, embed mount; OR acceptable equal	Stainless steel	Electropolish	NA	NA
○	Bollard	Urban Accessories DG4 cast recycled aluminum tapered base bollard w/ cast silicon-bronze cap; OR acceptable equal	Brahman Beige	Polished bronze cap; Powder coat finish with zinc-rich primer	NA	NA
◎	Removable Bollard	Urban Accessories DG4 cast recycled aluminum tapered base bollard w/ cast silicon-bronze cap, including upper base pate and inground base w/ pipe sleeve; OR acceptable equal	Brahman Beige	Polished bronze cap; Powder coat finish with zinc-rich primer	NA	NA
□	Tree Grate 5x5	Iron Age "Interlaken" 5ft x 5ft Cast iron tree grate w/ openings less than 1/2" & matching metal frame as recommended by manufacturer; OR acceptable equal for tree grate and metal frame	NA	Baked on oil	1.25" edge thickness	Circles and diamonds

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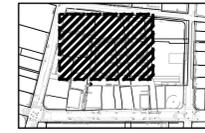
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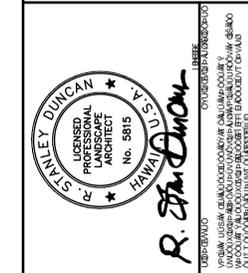
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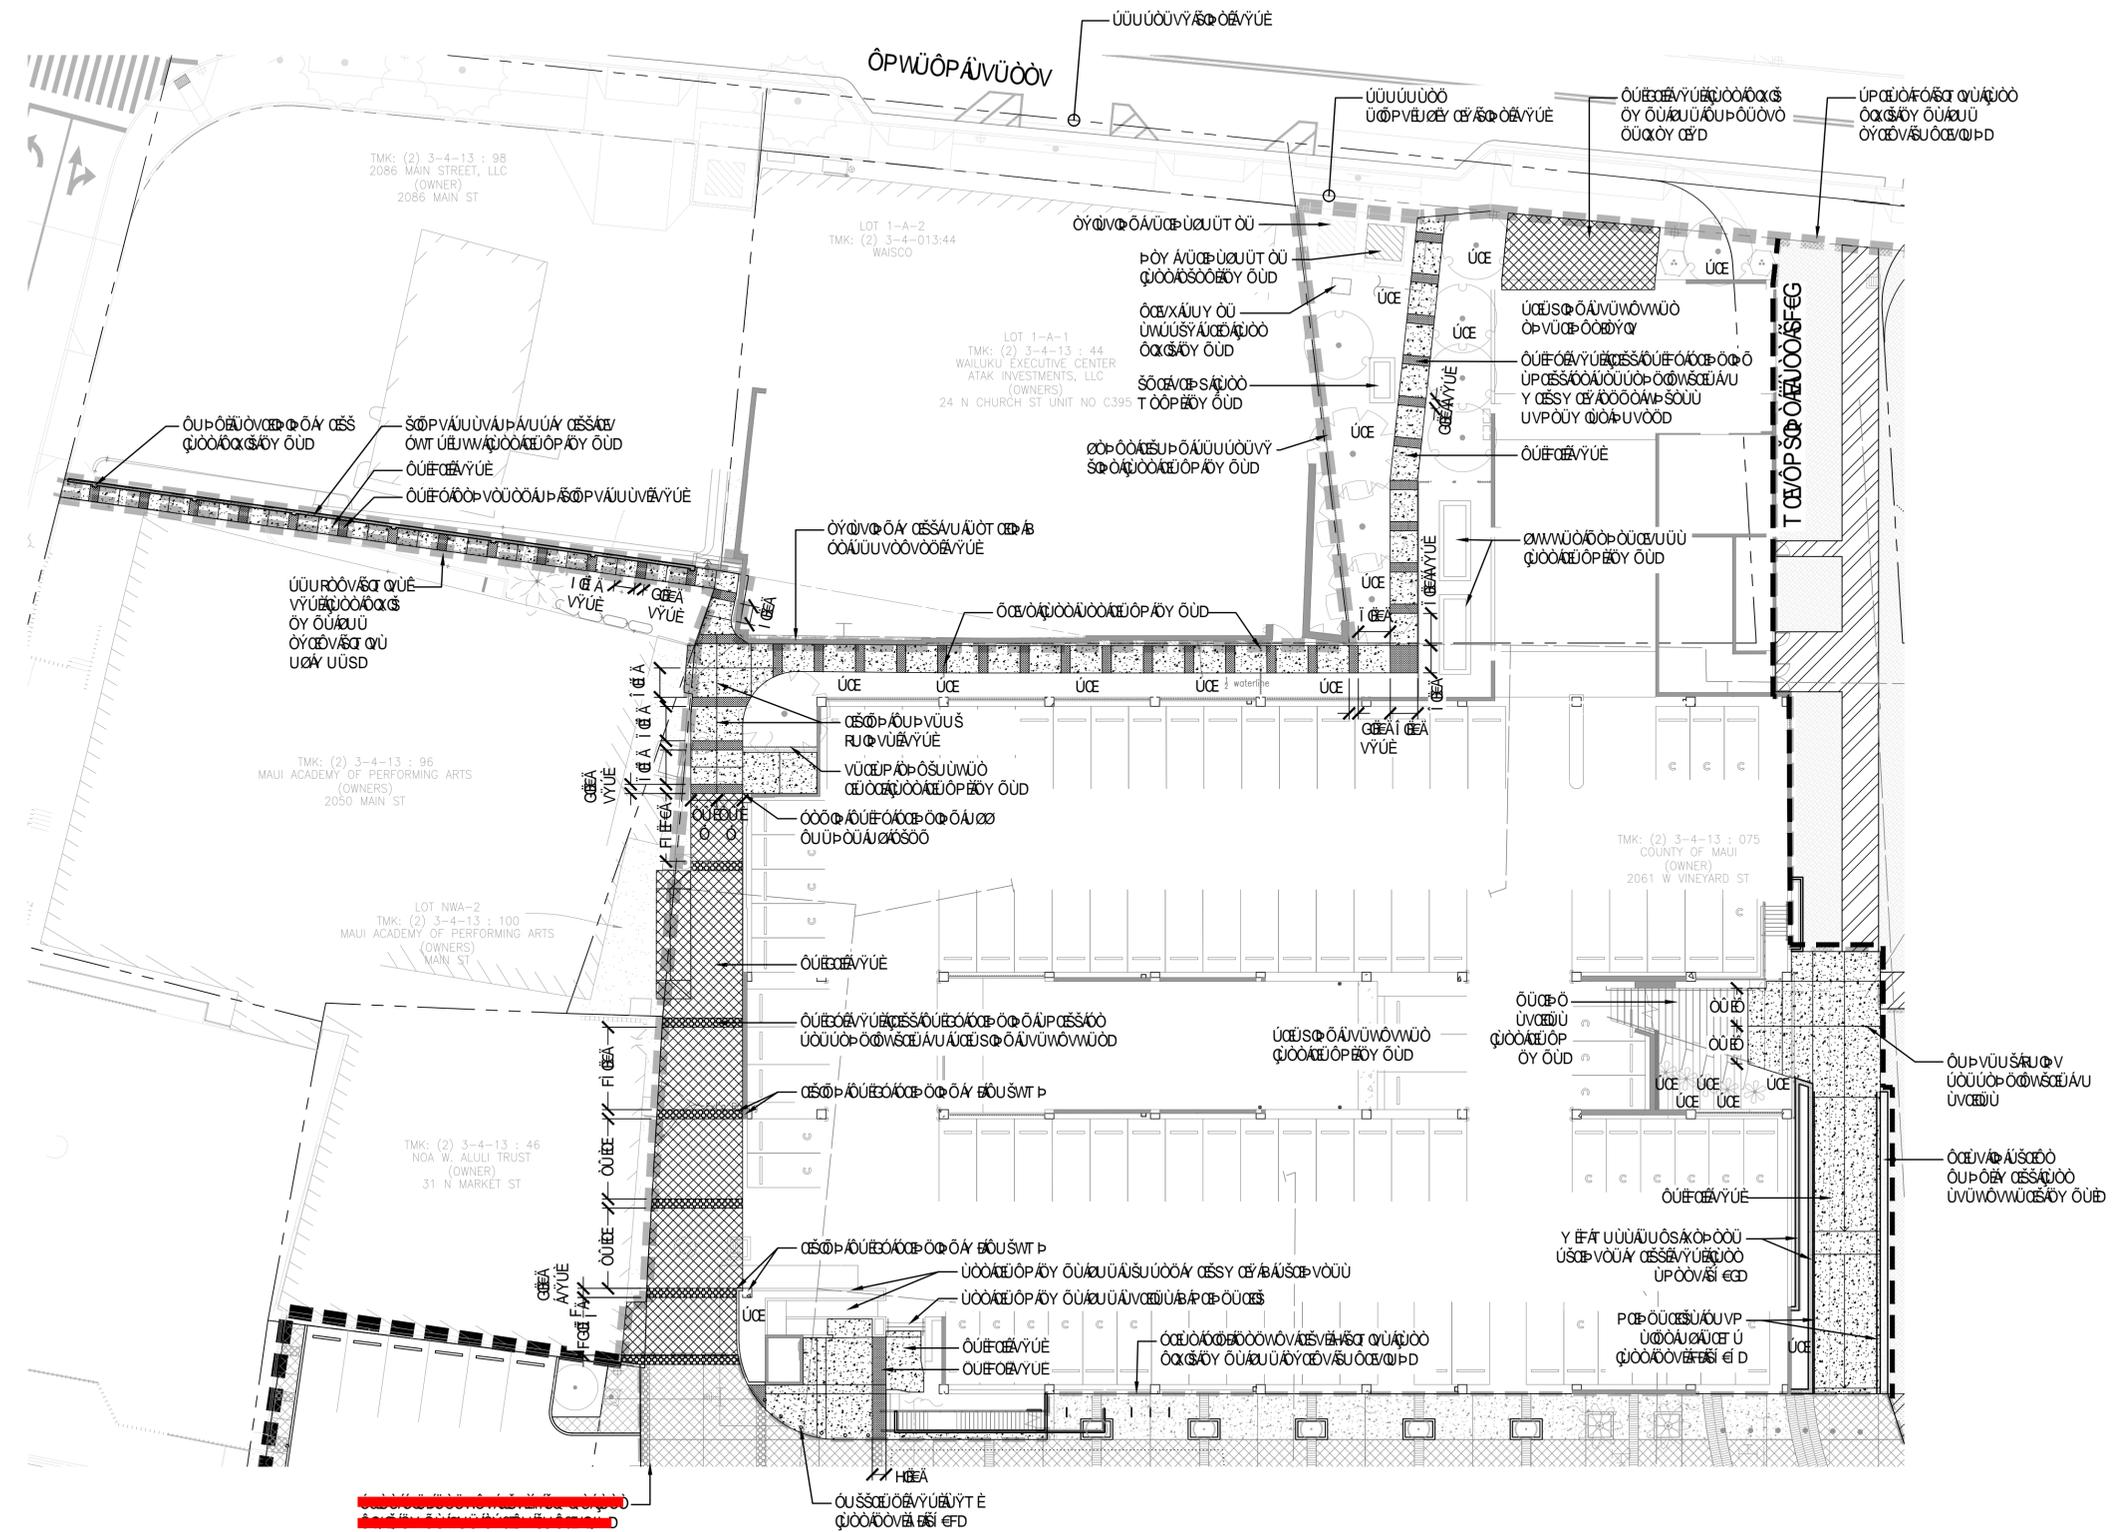
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ΠΡΟΤΥΠΟ
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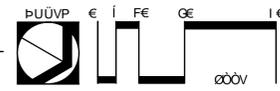


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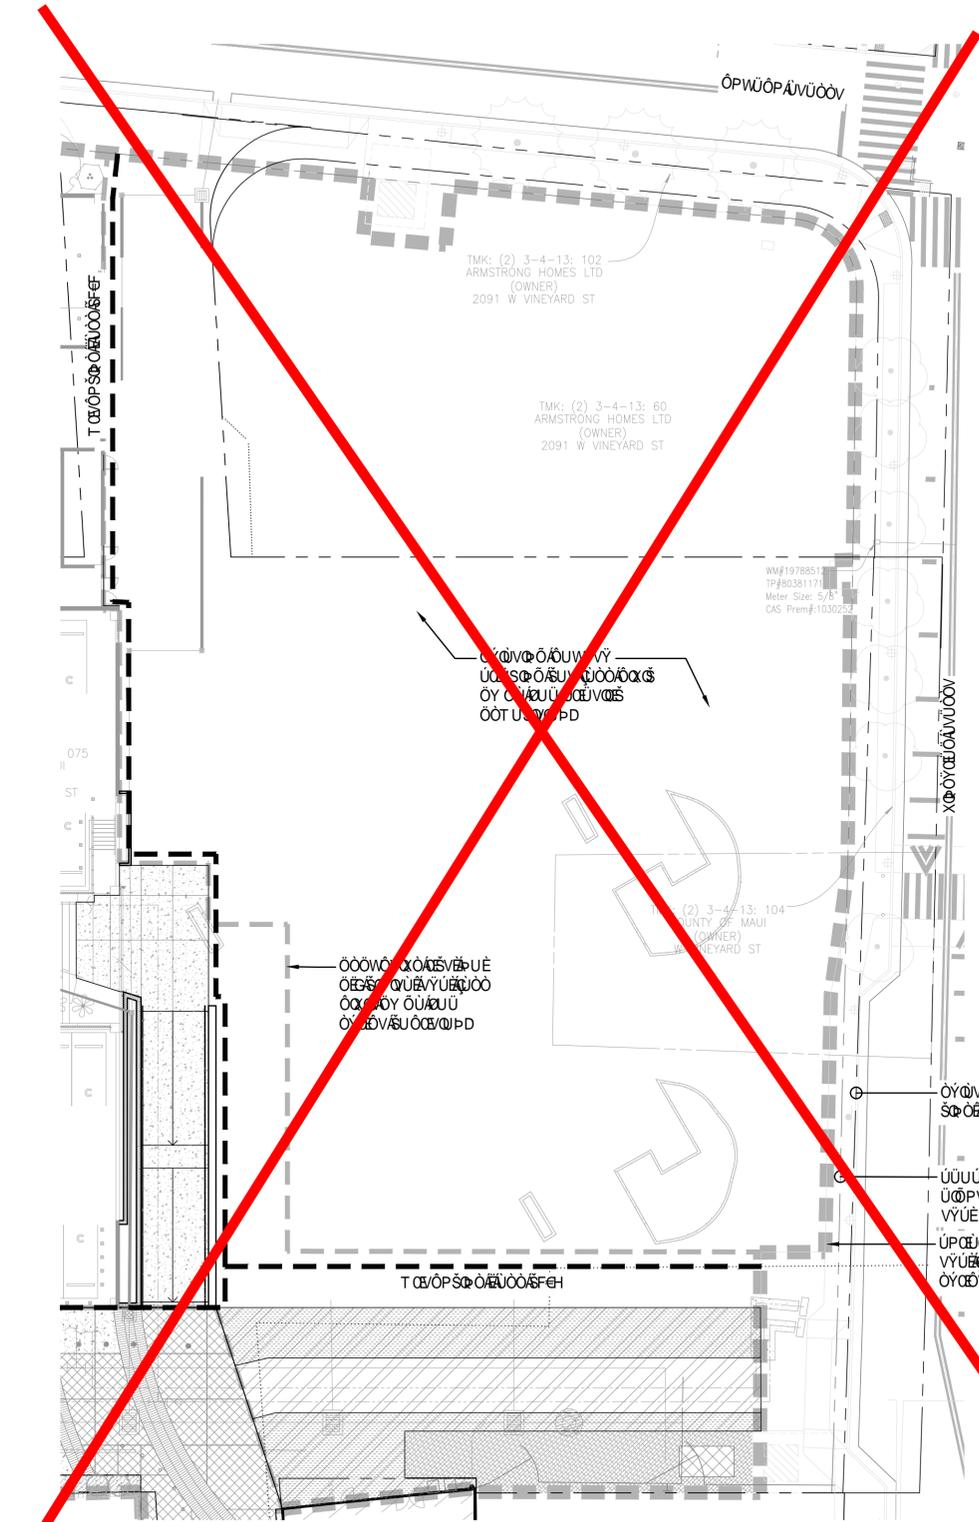
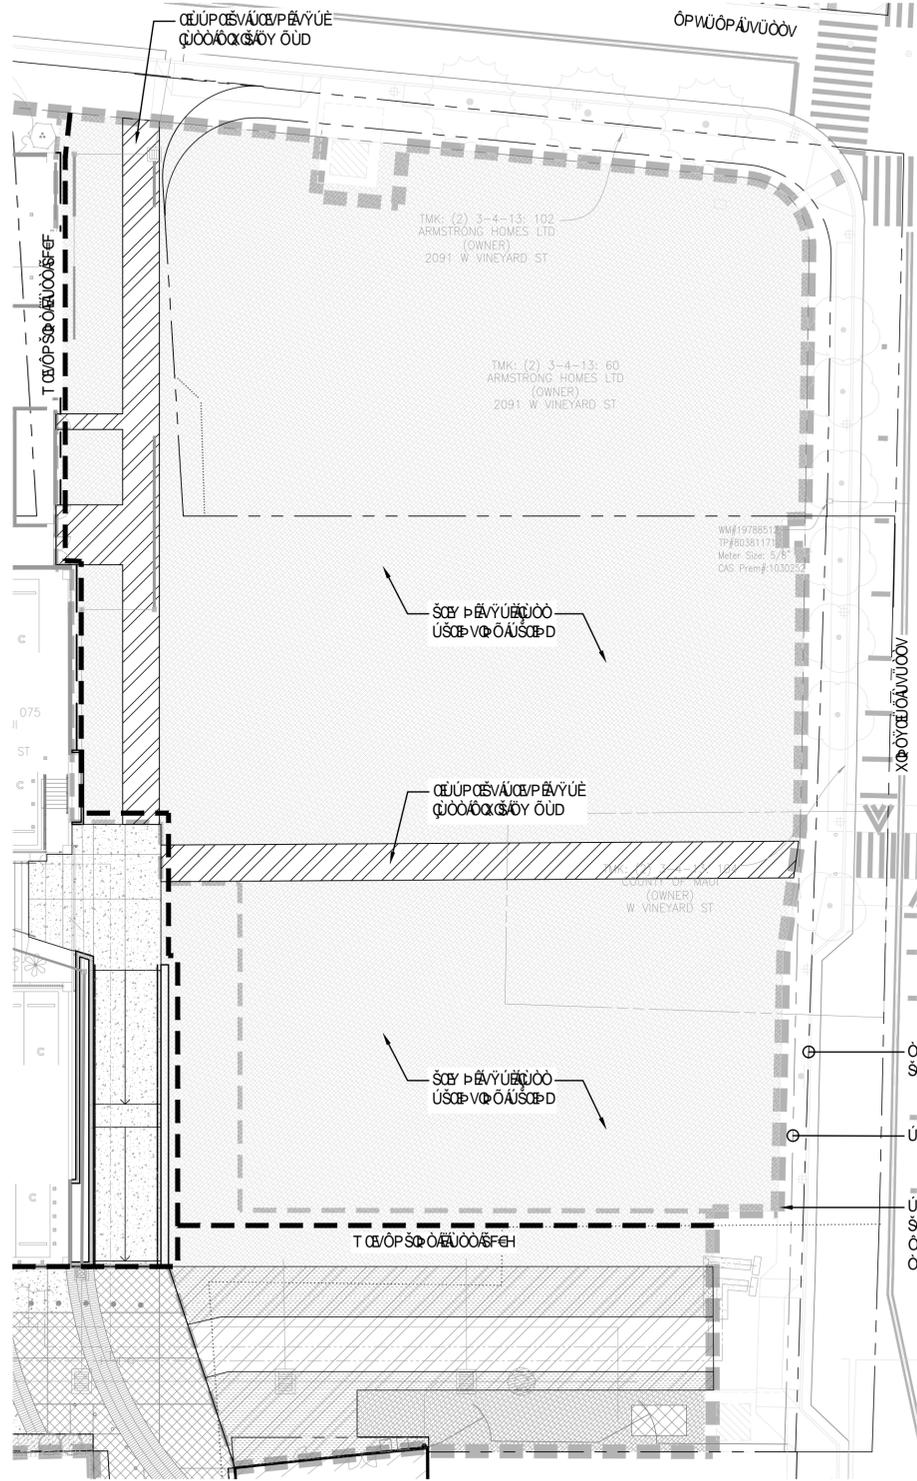
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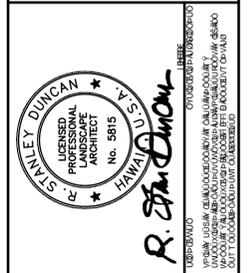


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SOYAT CHOI

FERRARO CHOI





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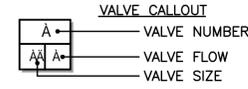
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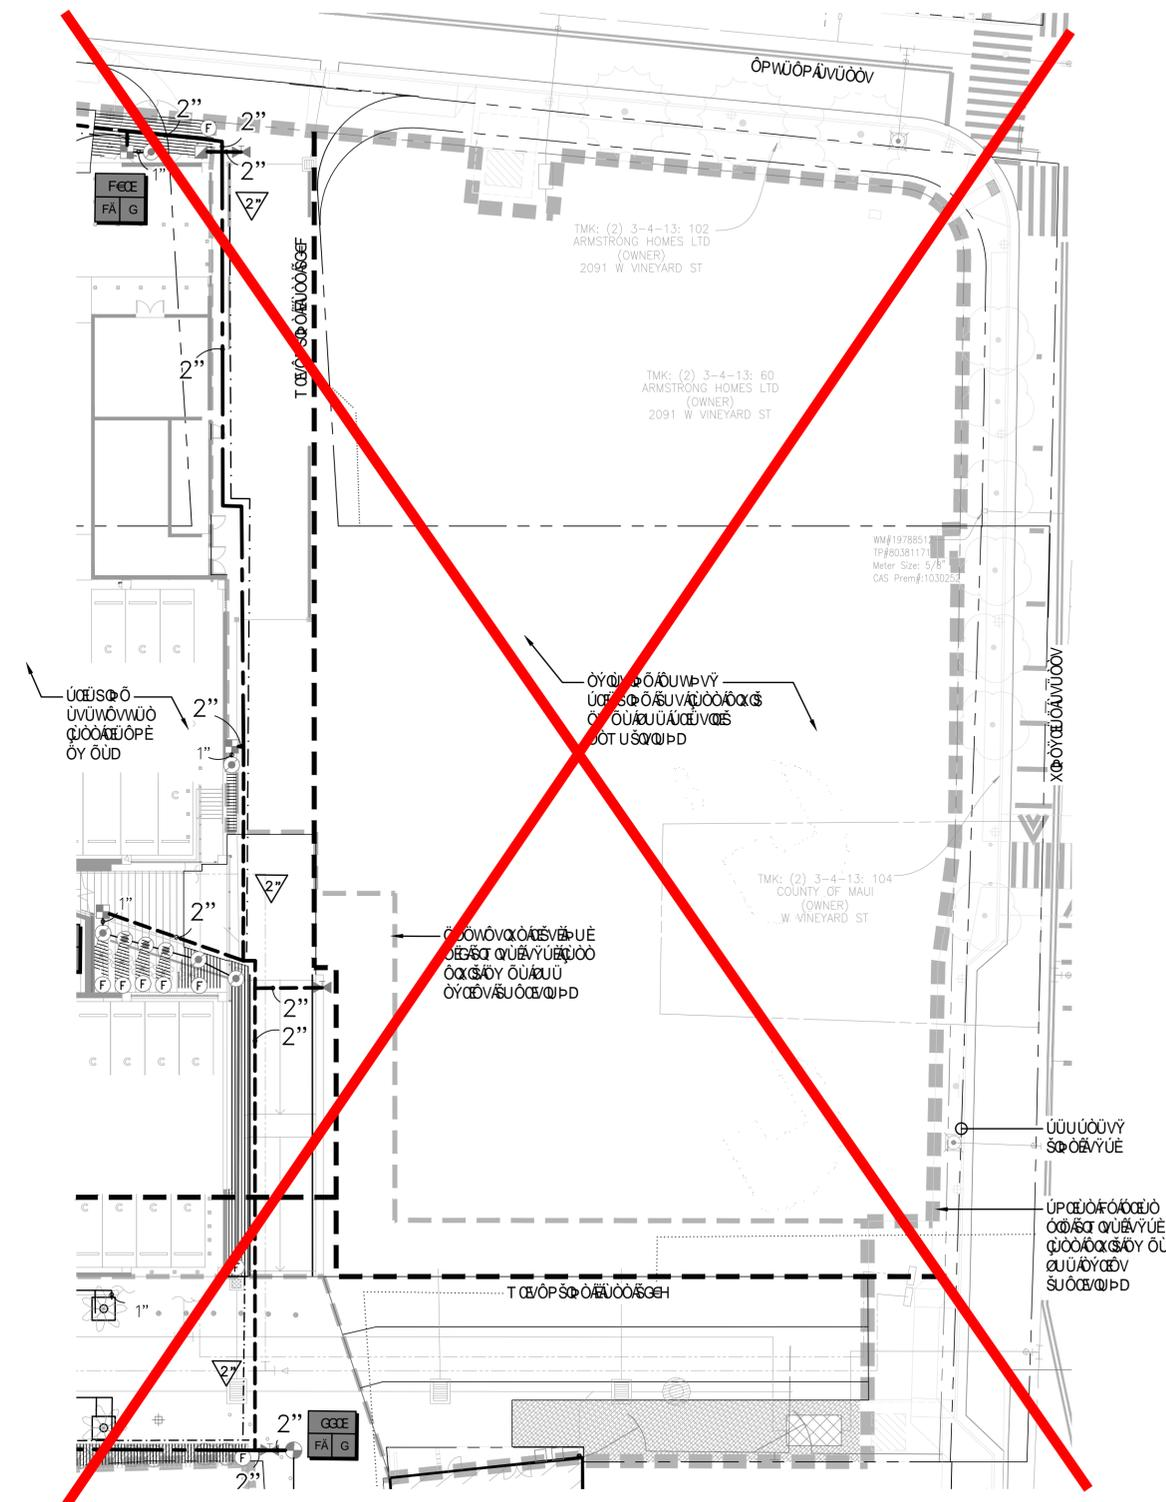
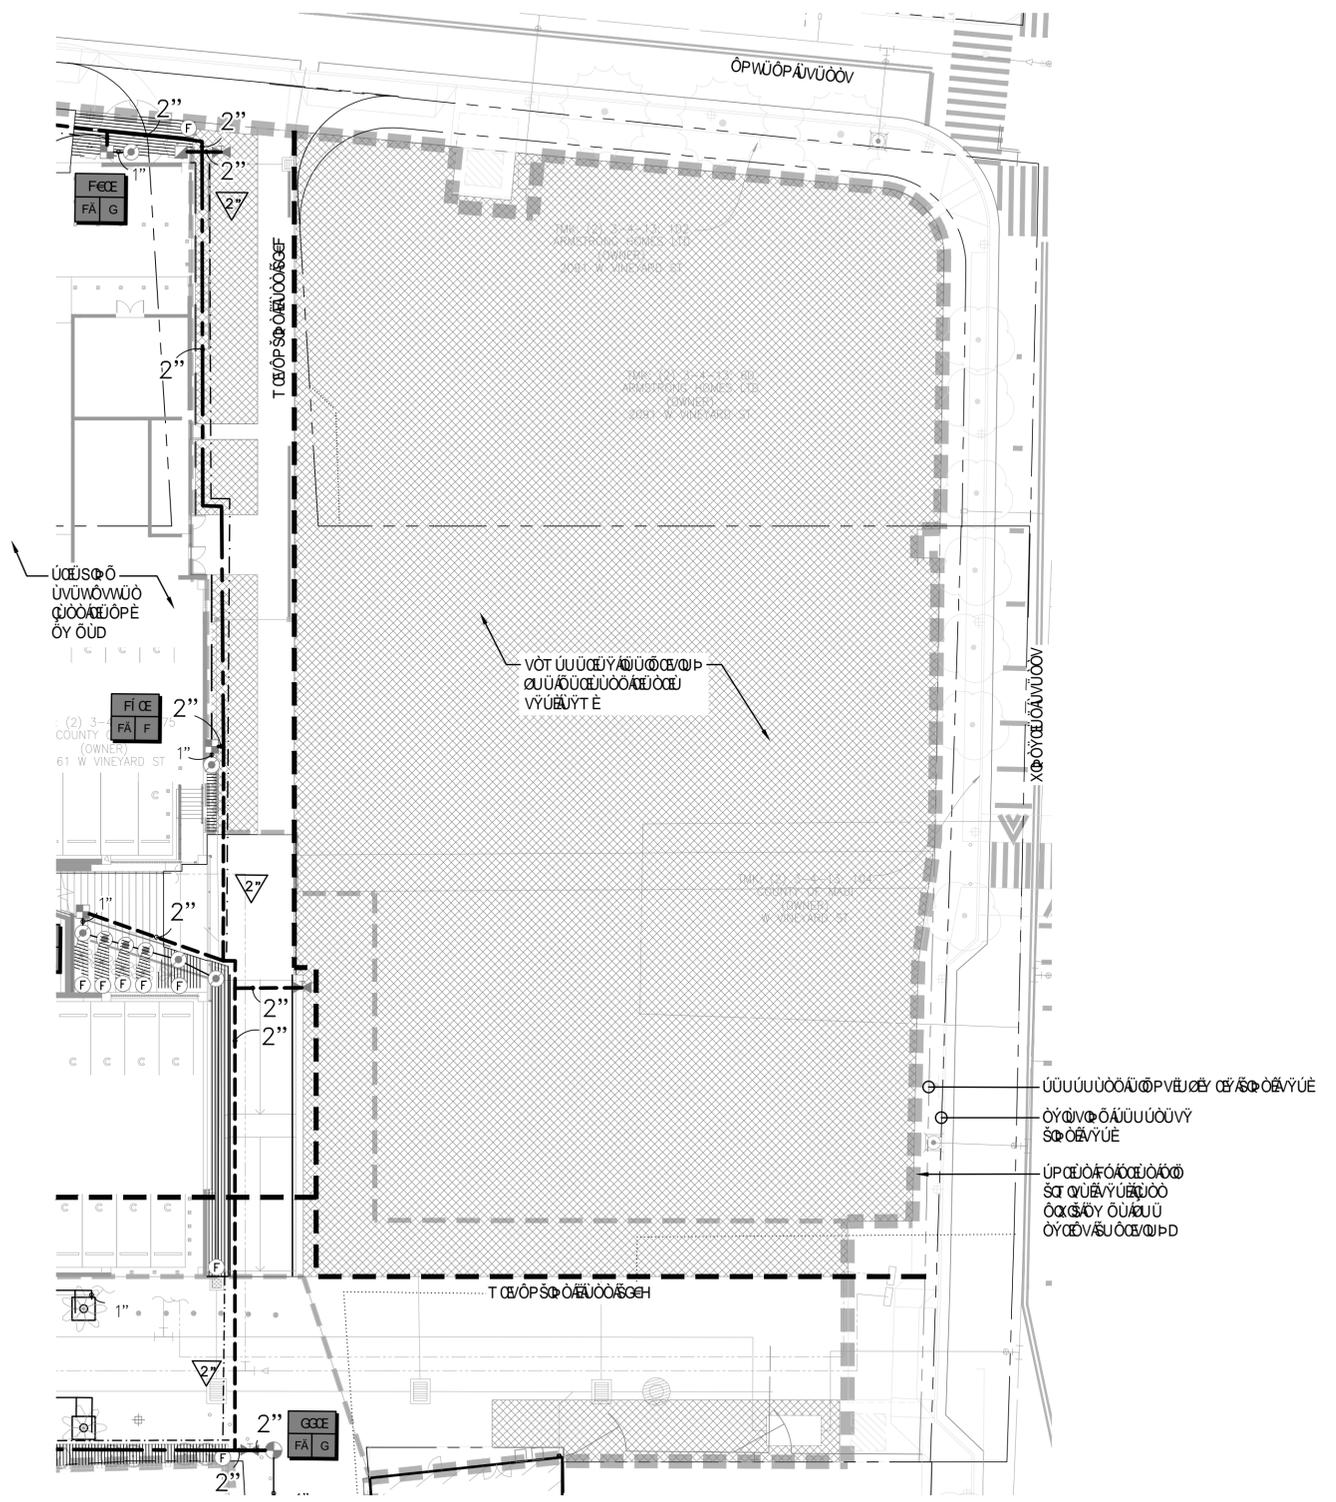


ΠΛΑΝΟ

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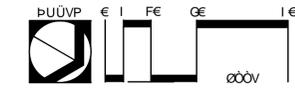
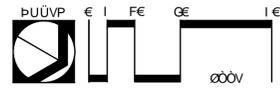


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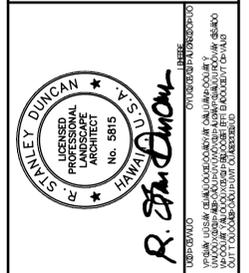

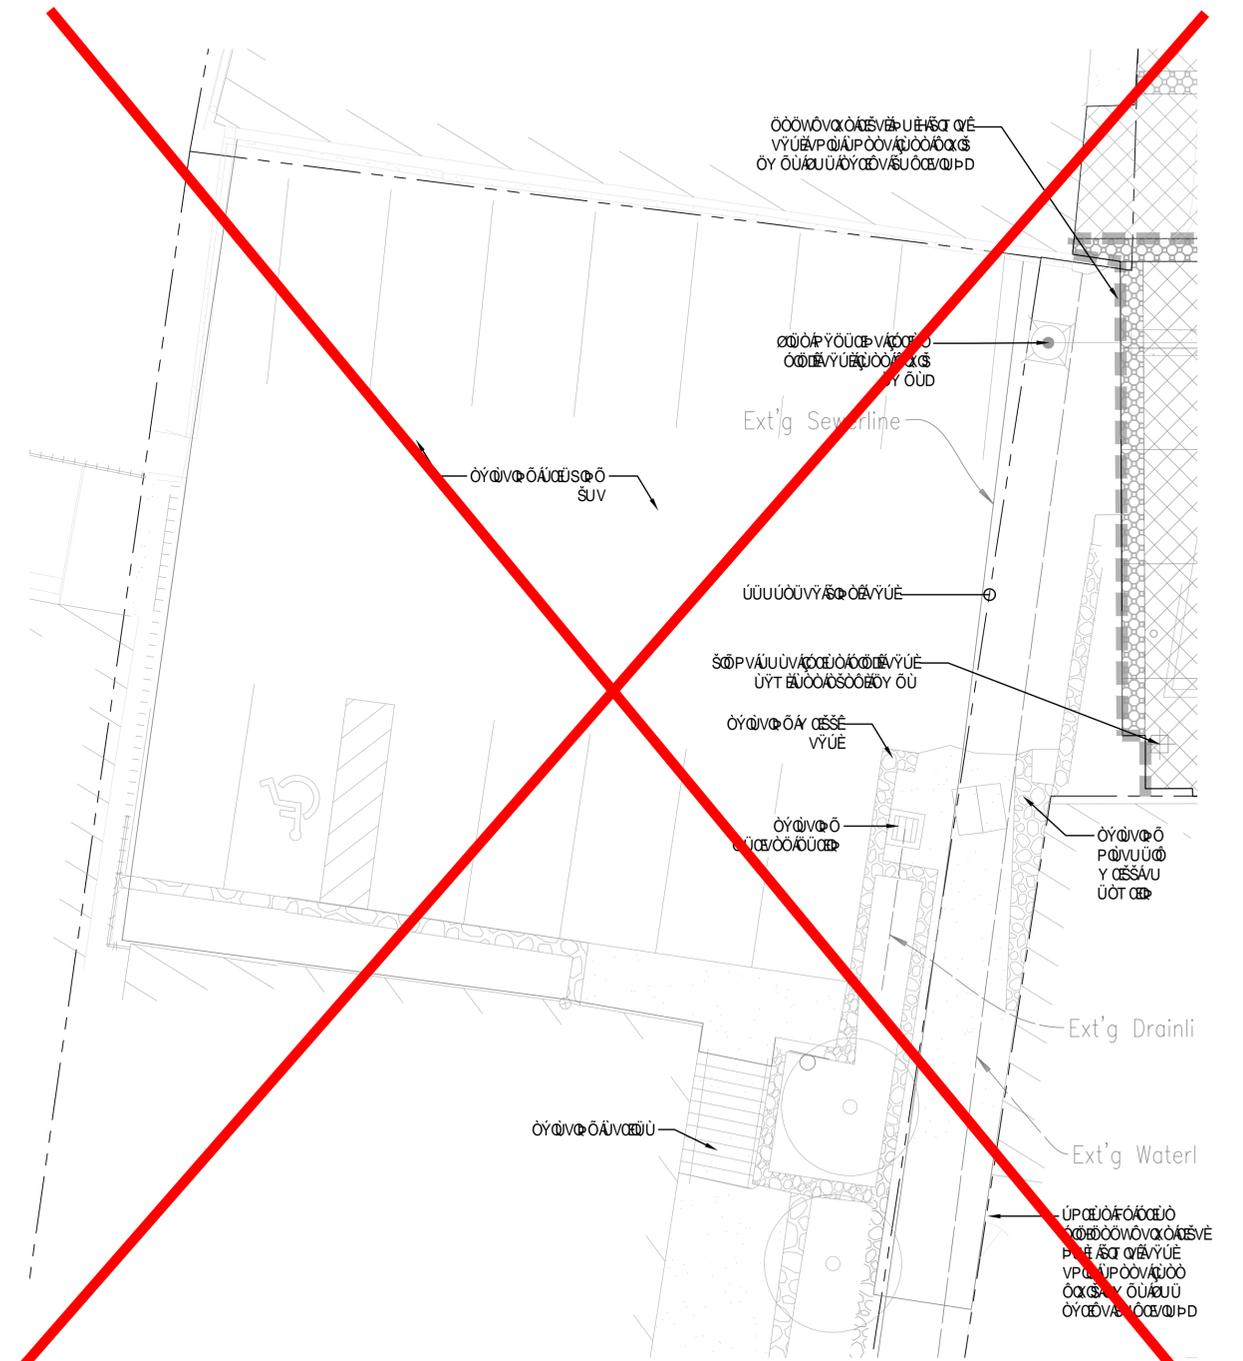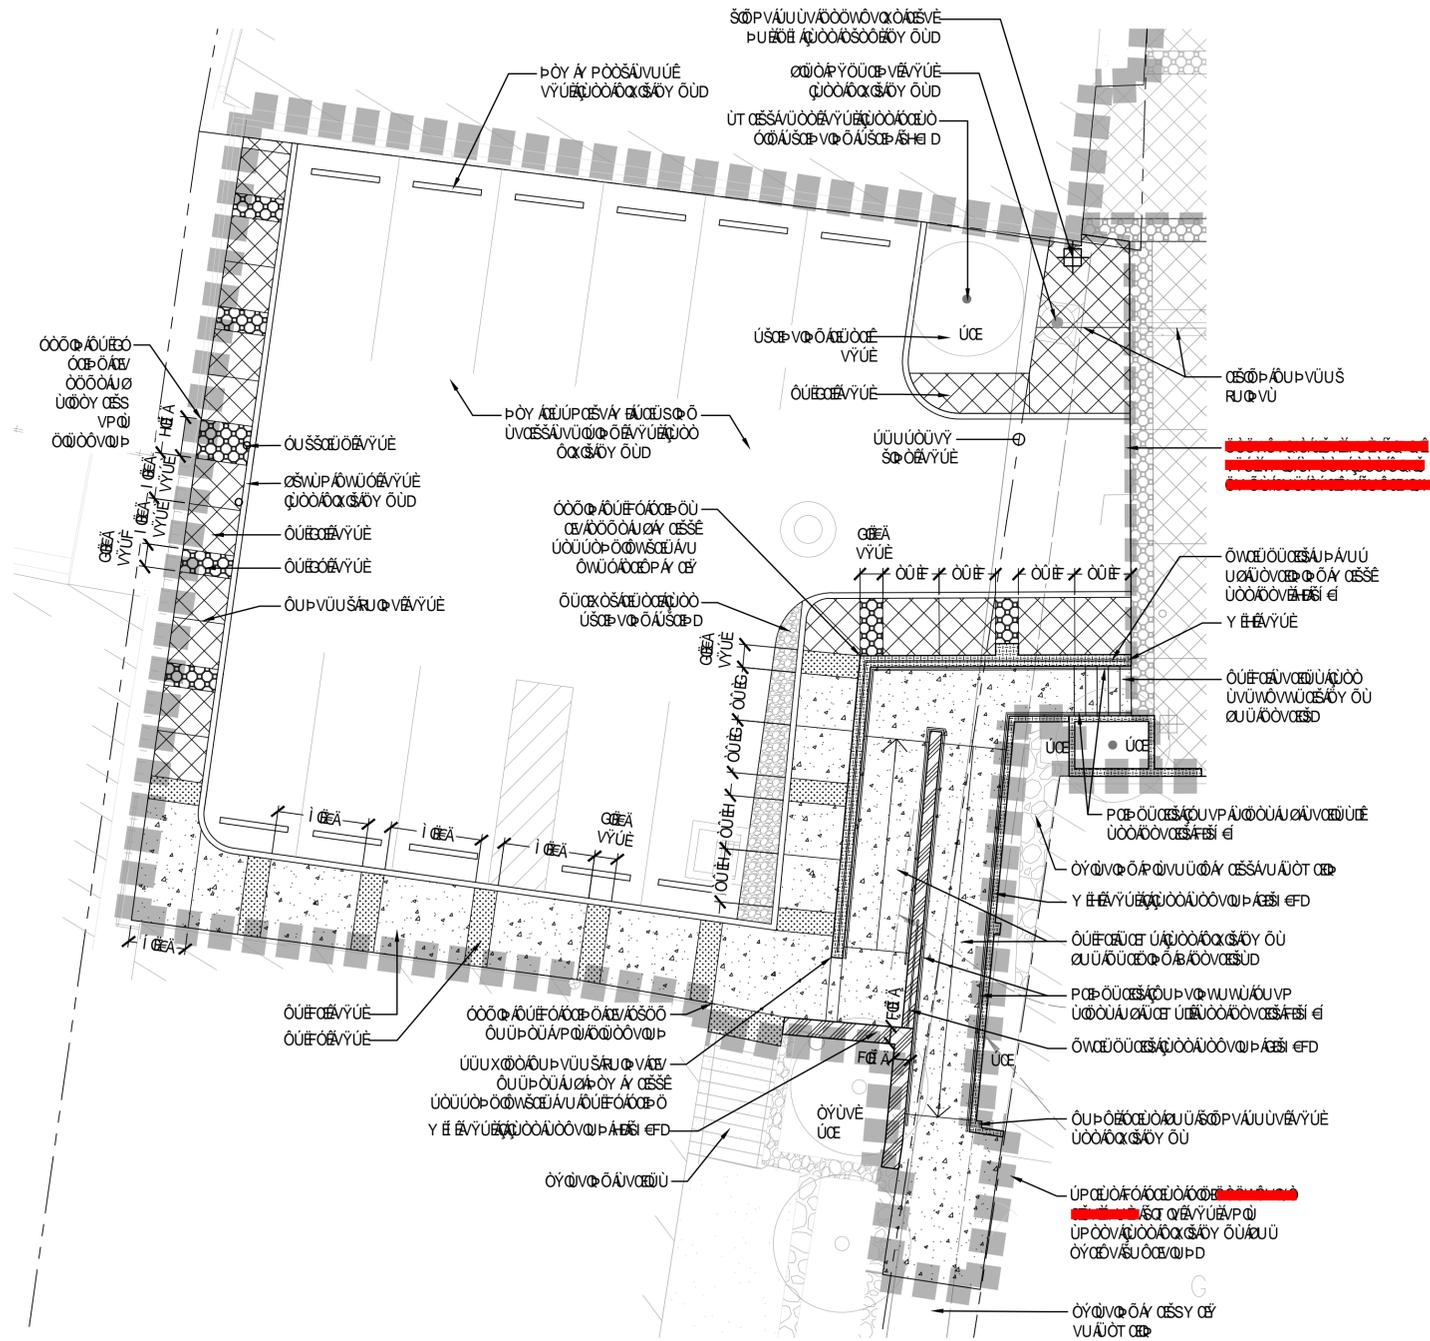
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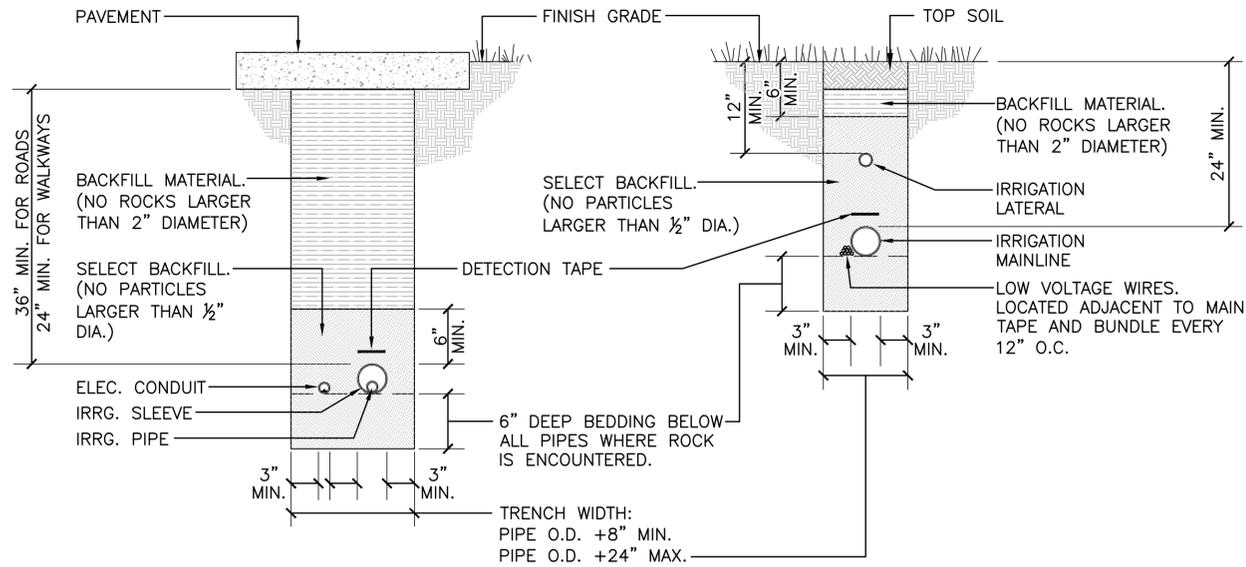
FERRARO CHOI



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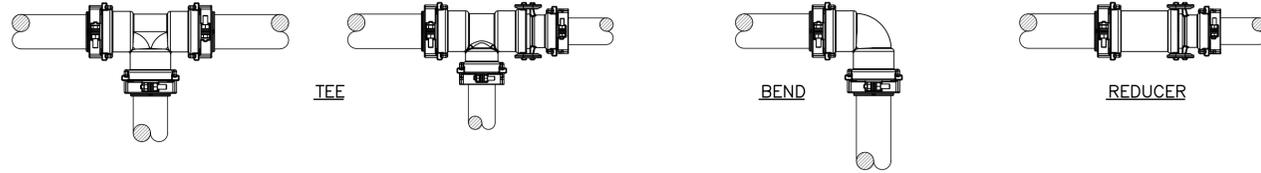
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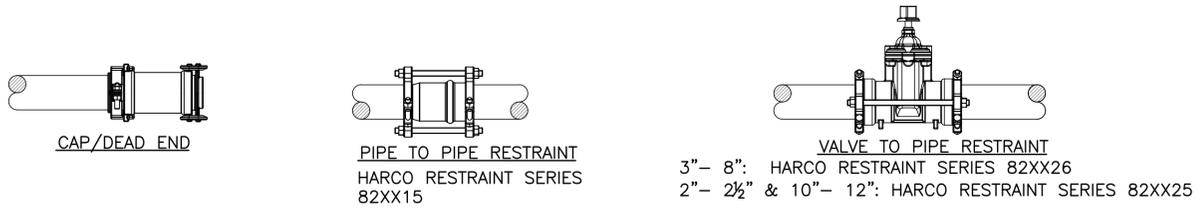


1 IRRIGATION TRENCHING DETAIL

1" = 1"



FITTING BELLS 4" AND BELOW: HARCO FITTING TO PIPE RESTRAINT SERIES 60-100-XX OR 82XX10
 FITTING BELLS 6" AND ABOVE: HARCO FITTING TO PIPE RESTRAINT SERIES 82XX11




MINIMUM RESTRAINED LENGTH REQUIREMENTS FOR EACH FITTING/VALVE BELL							
	90° BEND	45°, 22½°, 11¼° BEND	TEE	REDUCER	CAP/DEAD END	VALVE	COUPLING/SERVICE TEE (SEE NOTE 3)
4" & SMALLER	20'	20'	20'	40'	60'	60'	none
6" & LARGER	40'	20'	20'	60'	80'	80'	none

1. EACH FITTING & VALVE BELL MUST BE RESTRAINED TO THE LENGTH OF PIPE NOTED IN THE TABLE USING FITTING TO PIPE RESTRAINT, VALVE TO PIPE RESTRAINT, AND PIPE TO PIPE RESTRAINT AS REQUIRED.
2. PIPE JOINTS WITHIN THE RESTRAINED LENGTH REQUIREMENT MUST BE RESTRAINED WITH PIPE TO PIPE RESTRAINTS.
3. SERVICE TEES AND COUPLINGS WITHIN THE RESTRAINED LENGTH REQUIREMENT MUST BE RESTRAINED WITH FITTING TO PIPE RESTRAINTS.
4. THE RESTRAINT SCHEMES ARE FOR SYSTEM PRESSURES UP TO 125 PSI. CALL FOR HIGHER SYSTEM PRESSURES ALL FITTING & VALVE BELLS SHALL BE RESTRAINED AS SHOWN

2 JOINT RESTRAINT FITTINGS DETAIL

1" = 1'-0"

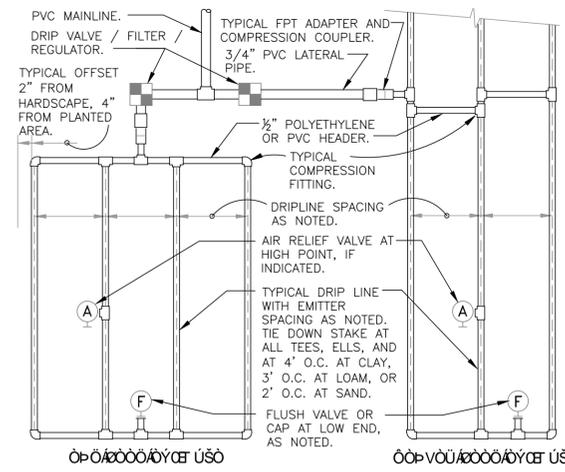

- SLOPED CONDITION NOTE:
1. INSTALL AIR RELIEF VALVE AT HIGHEST POINT.
 2. SPACING AS NOTED ON TOP ⅓ OF SLOPE.
 3. SPACING AT BOTTOM ⅓ AS NOTED PLUS 25%.
 4. WHEN ELEVATION CHANGE IS 10 FT OR MORE, ZONE BOTTOM ⅓ SEPARATELY.

PSI	EMITTER FLOW RATE GPH					
	12" SPACING		18" SPACING		24" SPACING	
10	125	96	175	135	218	171
20	249	191	350	171	442	340
30	373	286	524	256	663	510
40	500	381	700	350	884	680
50	625	476	875	438	1105	855
60	750	571	1050	525	1326	1020

EMITTER SPACING	LATERAL SPACING	EMITTER FLOW RATE	
12	12	0.96	1.44
18	18	0.69	1.03
24	24	0.28	0.41


EMITTER FLOW	12" SPACING	18" SPACING	24" SPACING
0.6 GPH	1.0 GPM	0.67 GPM	0.50 GPM
0.9 GPH	1.5 GPM	1.0 GPM	0.75 GPM

MAX GPM PSI LOSS		
SCHEDULE 40 PVC HEADER SIZE	1/2"	4.7 GPM
	3/4"	8.3 GPM
	1"	13.5 GPM
	1-1/2"	33.9 GPM
	2"	52.4 GPM

NOTE: REFER TO DRIPLINE LAYOUT EXAMPLES BELOW FOR DIFFERENT ACCEPTABLE CONFIGURATIONS.

3 TYPICAL DRIPLINE LAYOUT REQUIREMENTS

N.T.S.

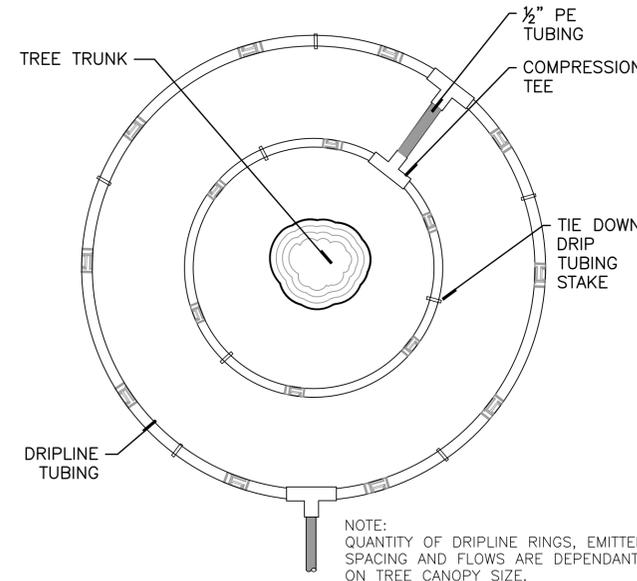

NOTE: QUANTITY OF DRIPLINE RINGS, EMITTER SPACING AND FLOWS ARE DEPENDANT ON TREE CANOPY SIZE.

5 DRIP TUBING AROUND TREES

NOT TO SCALE

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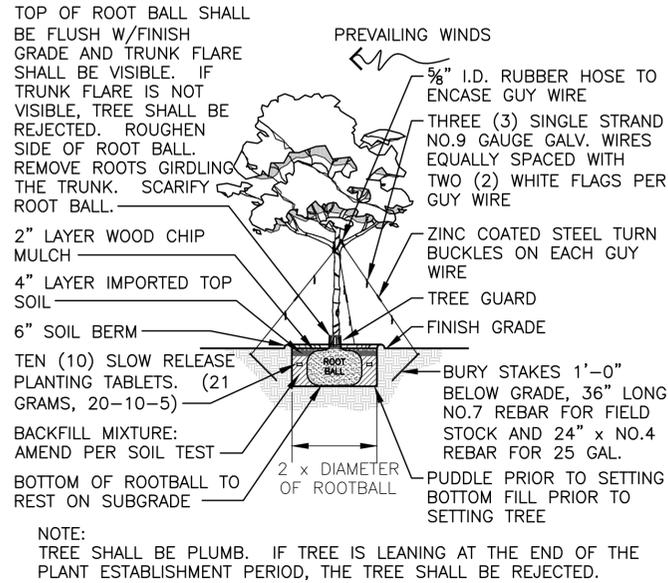


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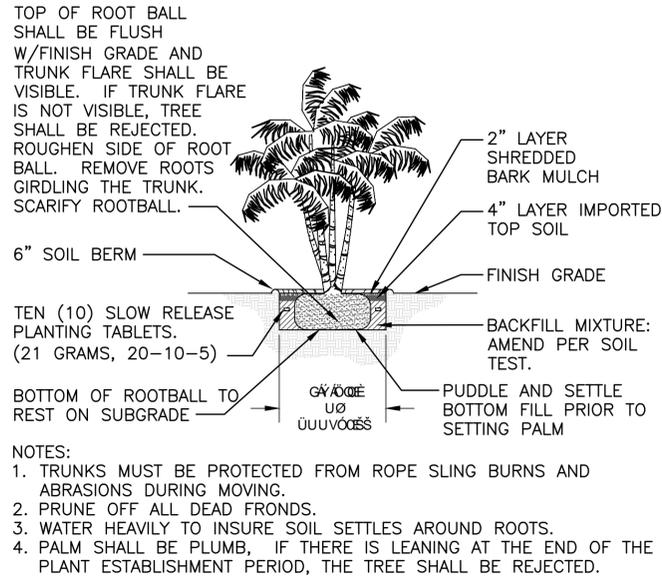
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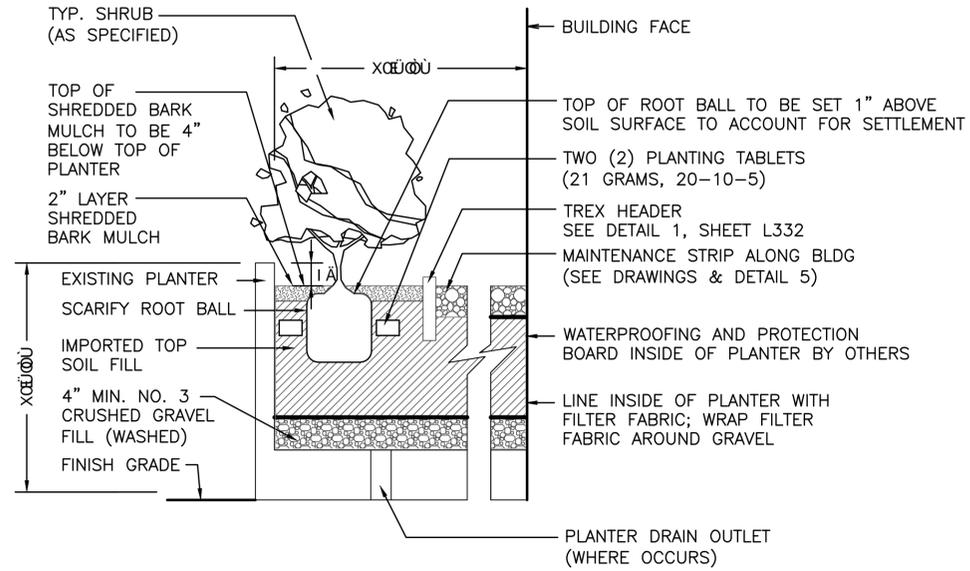
1 FIELD STOCK TREE PLANTING DETAIL

NOT TO SCALE



2 MULTI-TRUNK PALM PLANTING DETAIL

NOT TO SCALE



3 SHRUB PLANTIING IN OPEN BOTTOM PLANTER DETAIL

NOT TO SCALE

FERRARO CHOI



STANLEY DUNGAN
LICENSED PROFESSIONAL LANDSCAPE ARCHITECT
No. 8915
HAWAII

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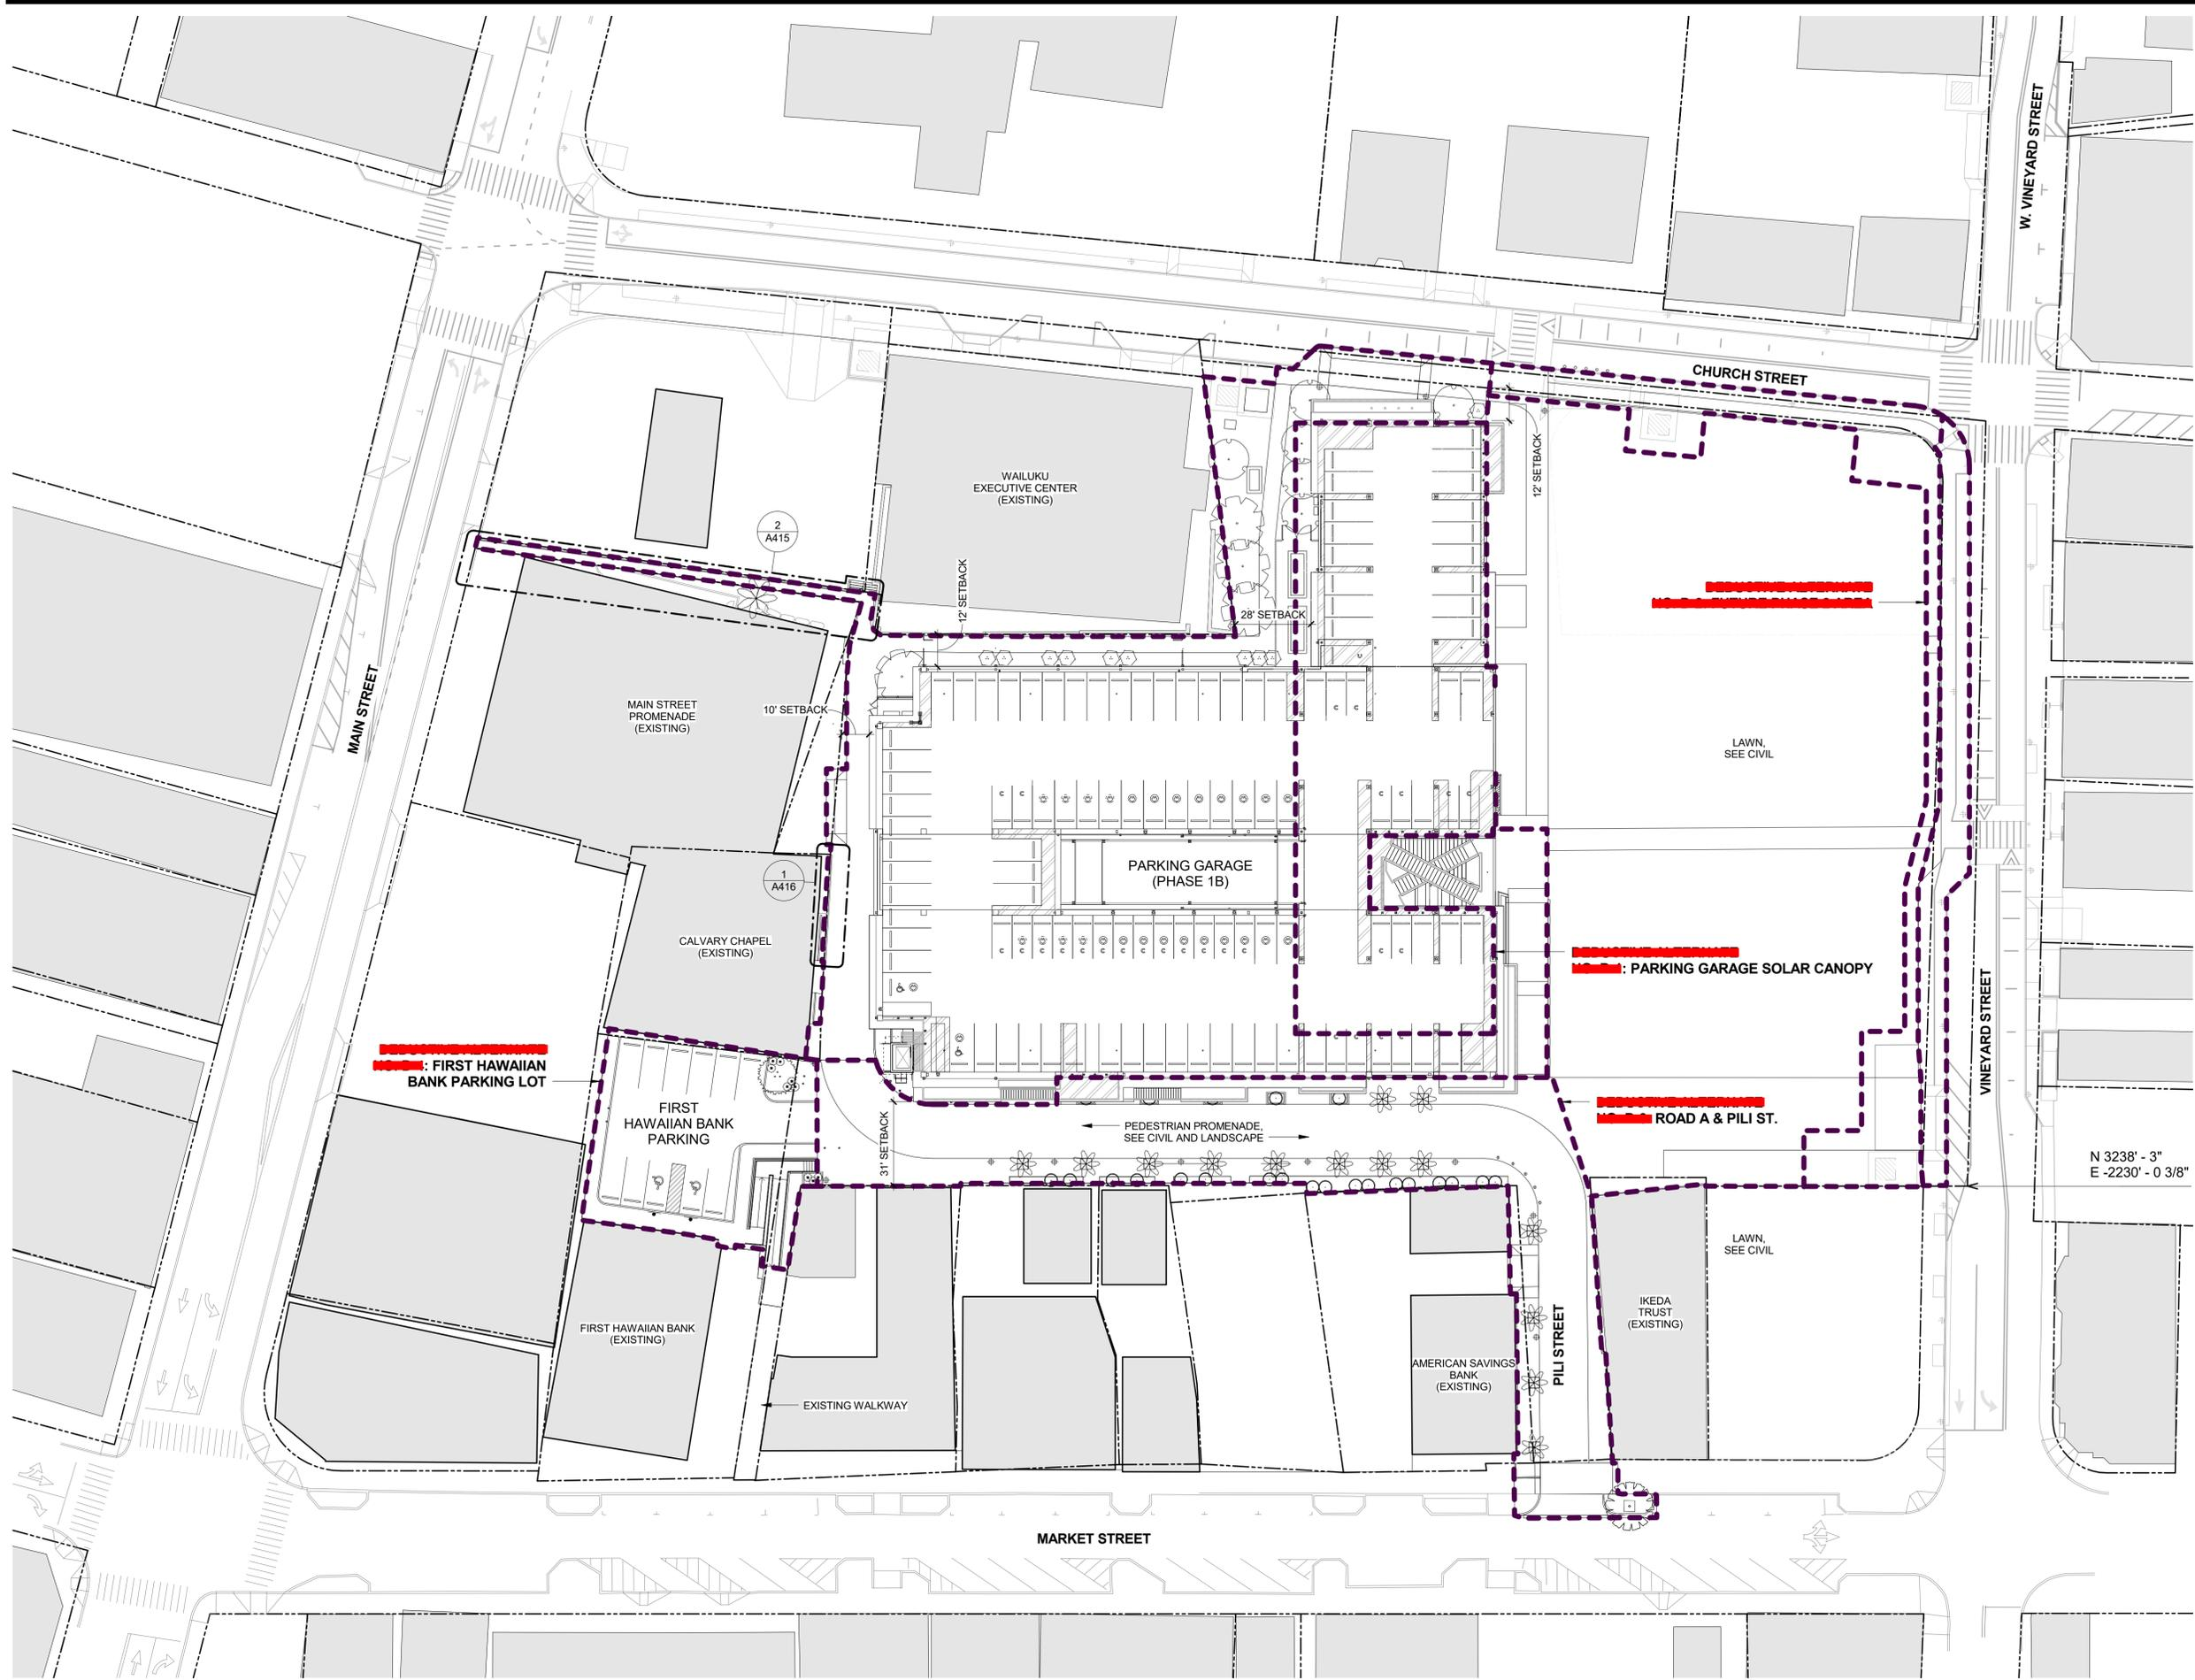
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SITE PLAN
 GENERAL NOTES:
 • REFER TO LANDSCAPE SITE PLANS, CIVIL SITE PLANS, AND MEP SITE PLANS FOR MORE INFORMATION.



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 1240 ALA MOANA BLVD., STE. 510, HONOLULU, HI 96814
 TEL 808.533.8880 FAX 808.599.3769 WWW.FERRAROCHOI.COM

WAILUKU CIVIC COMPLEX PHASE 1B
 100% FINAL DESIGN
 [PUVABUJUPUWUWUP]


SHEET TITLE:
SITE PLAN

PROJECT: 2017-001
 DRAWN: FCA
 DATE: 7/25/2019
 PHASE: SHEET: **1B A100**
 OF SHEETS

LEGEND:
 - - - - - PROPERTY LINE
 - - - - - BASE BID / DEDUCTIVE ALTERNATE LIMITS

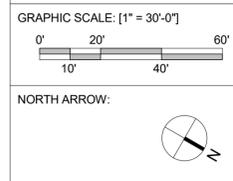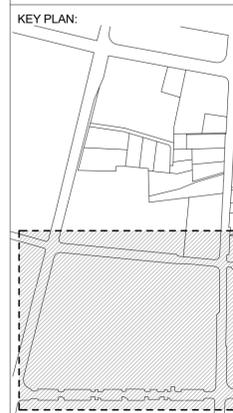

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OVERALL BUILDING PLANS

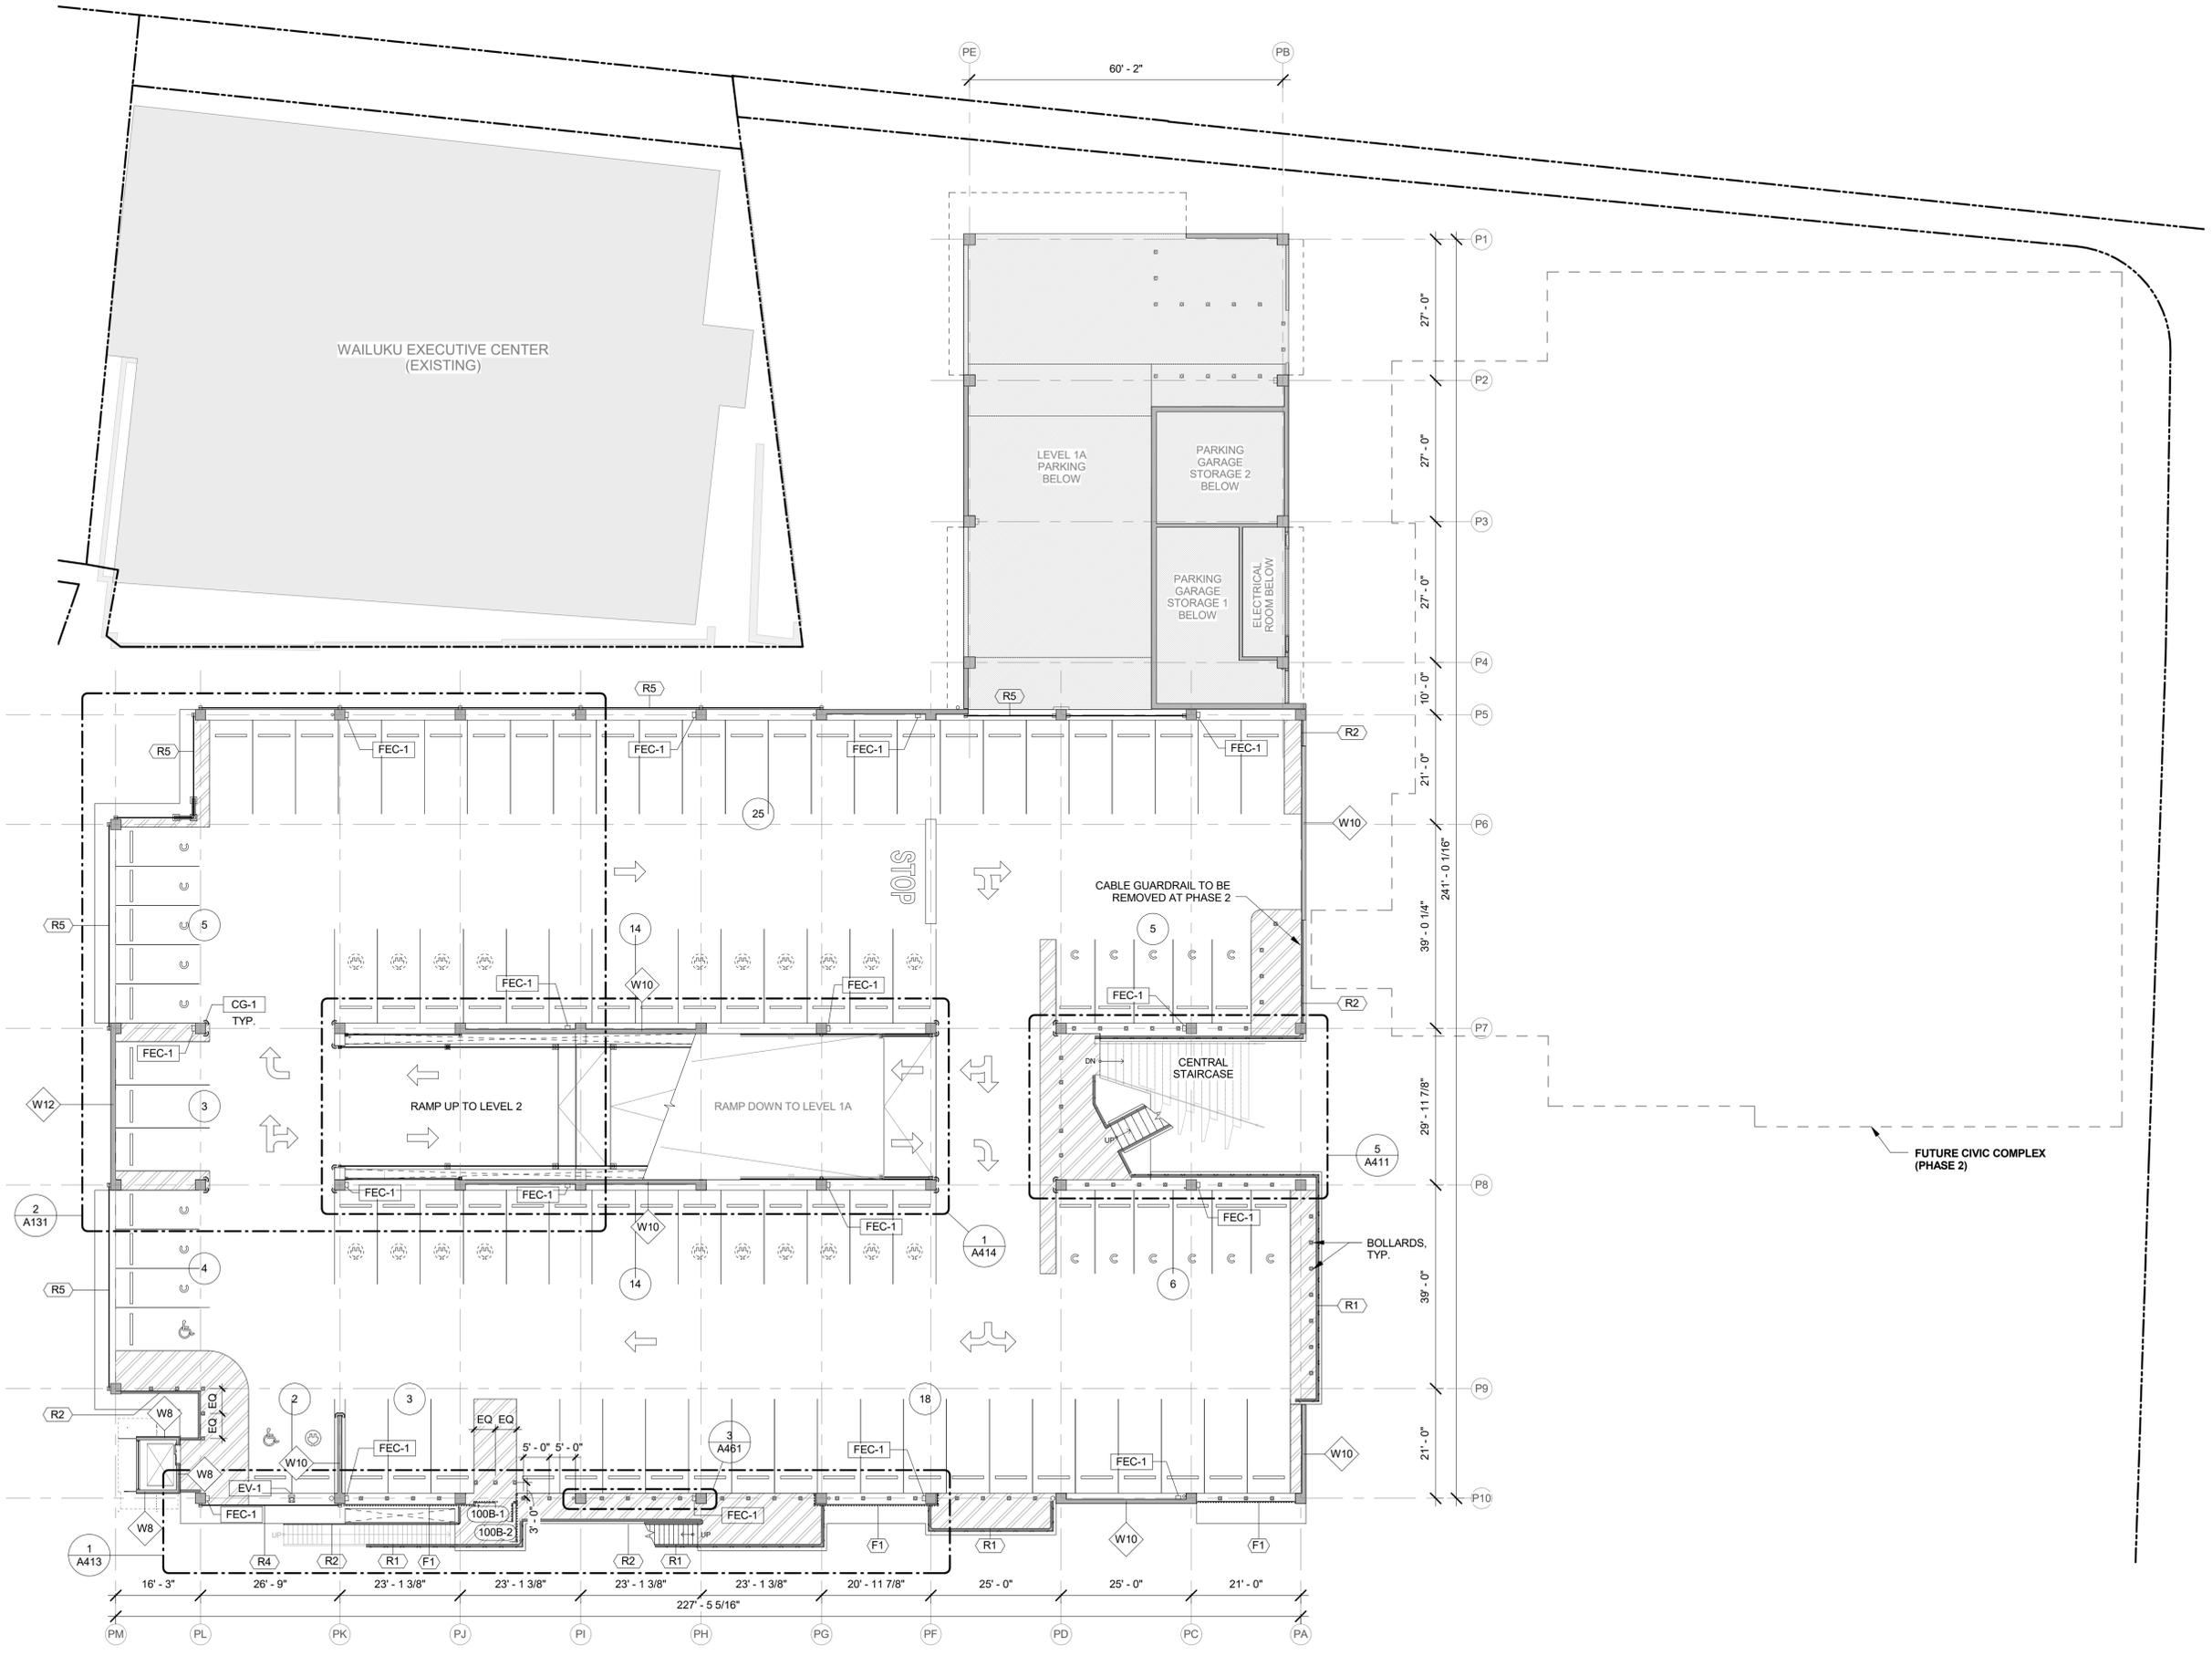GENERAL NOTES:

- EXTERIOR DIMENSIONS ARE TO FACE OF STUD, FACE OF CONCRETE/MASONRY, COLUMN CENTERLINE, OR CENTERLINE OF WINDOW U.O.N.
- INTERIOR DIMENSIONS ARE TO FACE OF STUD, FACE OF CONCRETE/MASONRY, OR COLUMN CENTERLINE U.O.N.
- DIMENSIONS DESIGNATED AS "CLEAR" SHALL BE MAINTAINED.
- MAINTAIN CONTINUITY OF RATED PARTITIONS AT HEAD AND BOTTOM OF PARTITION AND AT JOINTS WITH DISSIMILAR PARTITIONS WITH LISTED JOINT ASSEMBLIES.
- WHERE TWO DIFFERING PARTITION TYPES ABUT ALONG A CONTINUOUS LINE, THE CONTINUOUS FINISHED SURFACE OF THESE PARTITIONS SHALL ALIGN U.O.N.
- WHERE DOORS ARE NOT SPECIFICALLY LOCATED, PROVIDE A HINGE-SIDE JAMB DIMENSION OF 4" FROM DOOR OPENING TO ADJACENT PERPENDICULAR PARTITION.
- WHERE MECHANICAL DUCTWORK PENETRATES A COMPONENT OF THE FIRE-RATED ASSEMBLY, PROVIDE FIRE AND/OR SMOKE DAMPERS IN ACCORDANCE WITH IBC CHAPTER 7.

LEVEL 1B STALL COUNT

77	STANDARD
19	COMPACT
2	ADA-STANDARD
0	ADA-VAN
1	EV-STANDARD
0	EV-COMPACT
0	EV-ADA
99	TOTAL

LEGEND:

PARKING SYMBOLS

- ☐ COMPACT CAR STALL*
- ♿ ADA STALL*
- ⚡ EV STALL*
- # TOTAL NUMBER OF STALLS WITHIN RUN

*SYMBOL AS DASHED LINES INDICATE FUTURE DESIGNATION OF THESE STALLS

WALL TYPES

- ◊ W# CONCRETE WALL
- # = THICKNESS (INCHES)

RAILING / FENCE TYPES

- (R1) DECORATIVE W/ ILLUMINATED HANDRAIL
- (R2) CABLE
- (R24) CABLE W/ ILLUMINATED HANDRAIL
- (R3) HANDRAIL & POST
- (R34) ILLUMINATED HANDRAIL & POST
- (R4) VEHICLE BARRIER CABLE W/ WIRE MESH
- (R5) VEHICLE BARRIER CABLE W/ METAL SCREEN
- (F1) WOODGRAIN ALUMINUM FENCE
- (F2) SECURITY FENCE W/ WELDED WIRE MESH

SPECIAL EQUIPMENT

- CG-1 CORNER GUARD
- EV-1 EV CHARGING STATION
- FE-1 FIRE EXTINGUISHER
- FEC-1 FIRE EXTINGUISHER W/ CABINET

KEYPLAN:

GRAPHIC SCALE: [1/16" = 1'-0"]

NORTH ARROW:

FERRARO CHOI

FERRARO CHOI AND ASSOCIATES LTD
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TEL 808.533.8880 FAX 808.599.3769 www.ferrarochoi.com

WAILUKU CIVIC COMPLEX PHASE 1B

100% FINAL DESIGN

PROJECT: 2017-001 DRAWN: FCA DATE: 7/25/2019

SHEET: 1B A101B OF SHEETS: 10

SHEET TITLE: OVERALL FLOOR PLAN - LEVEL 1B

REVISIONS:

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PROJECT: 2017-001 DRAWN: FCA DATE: 7/25/2019

PHASE: 1B A101B OF SHEETS: 10

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